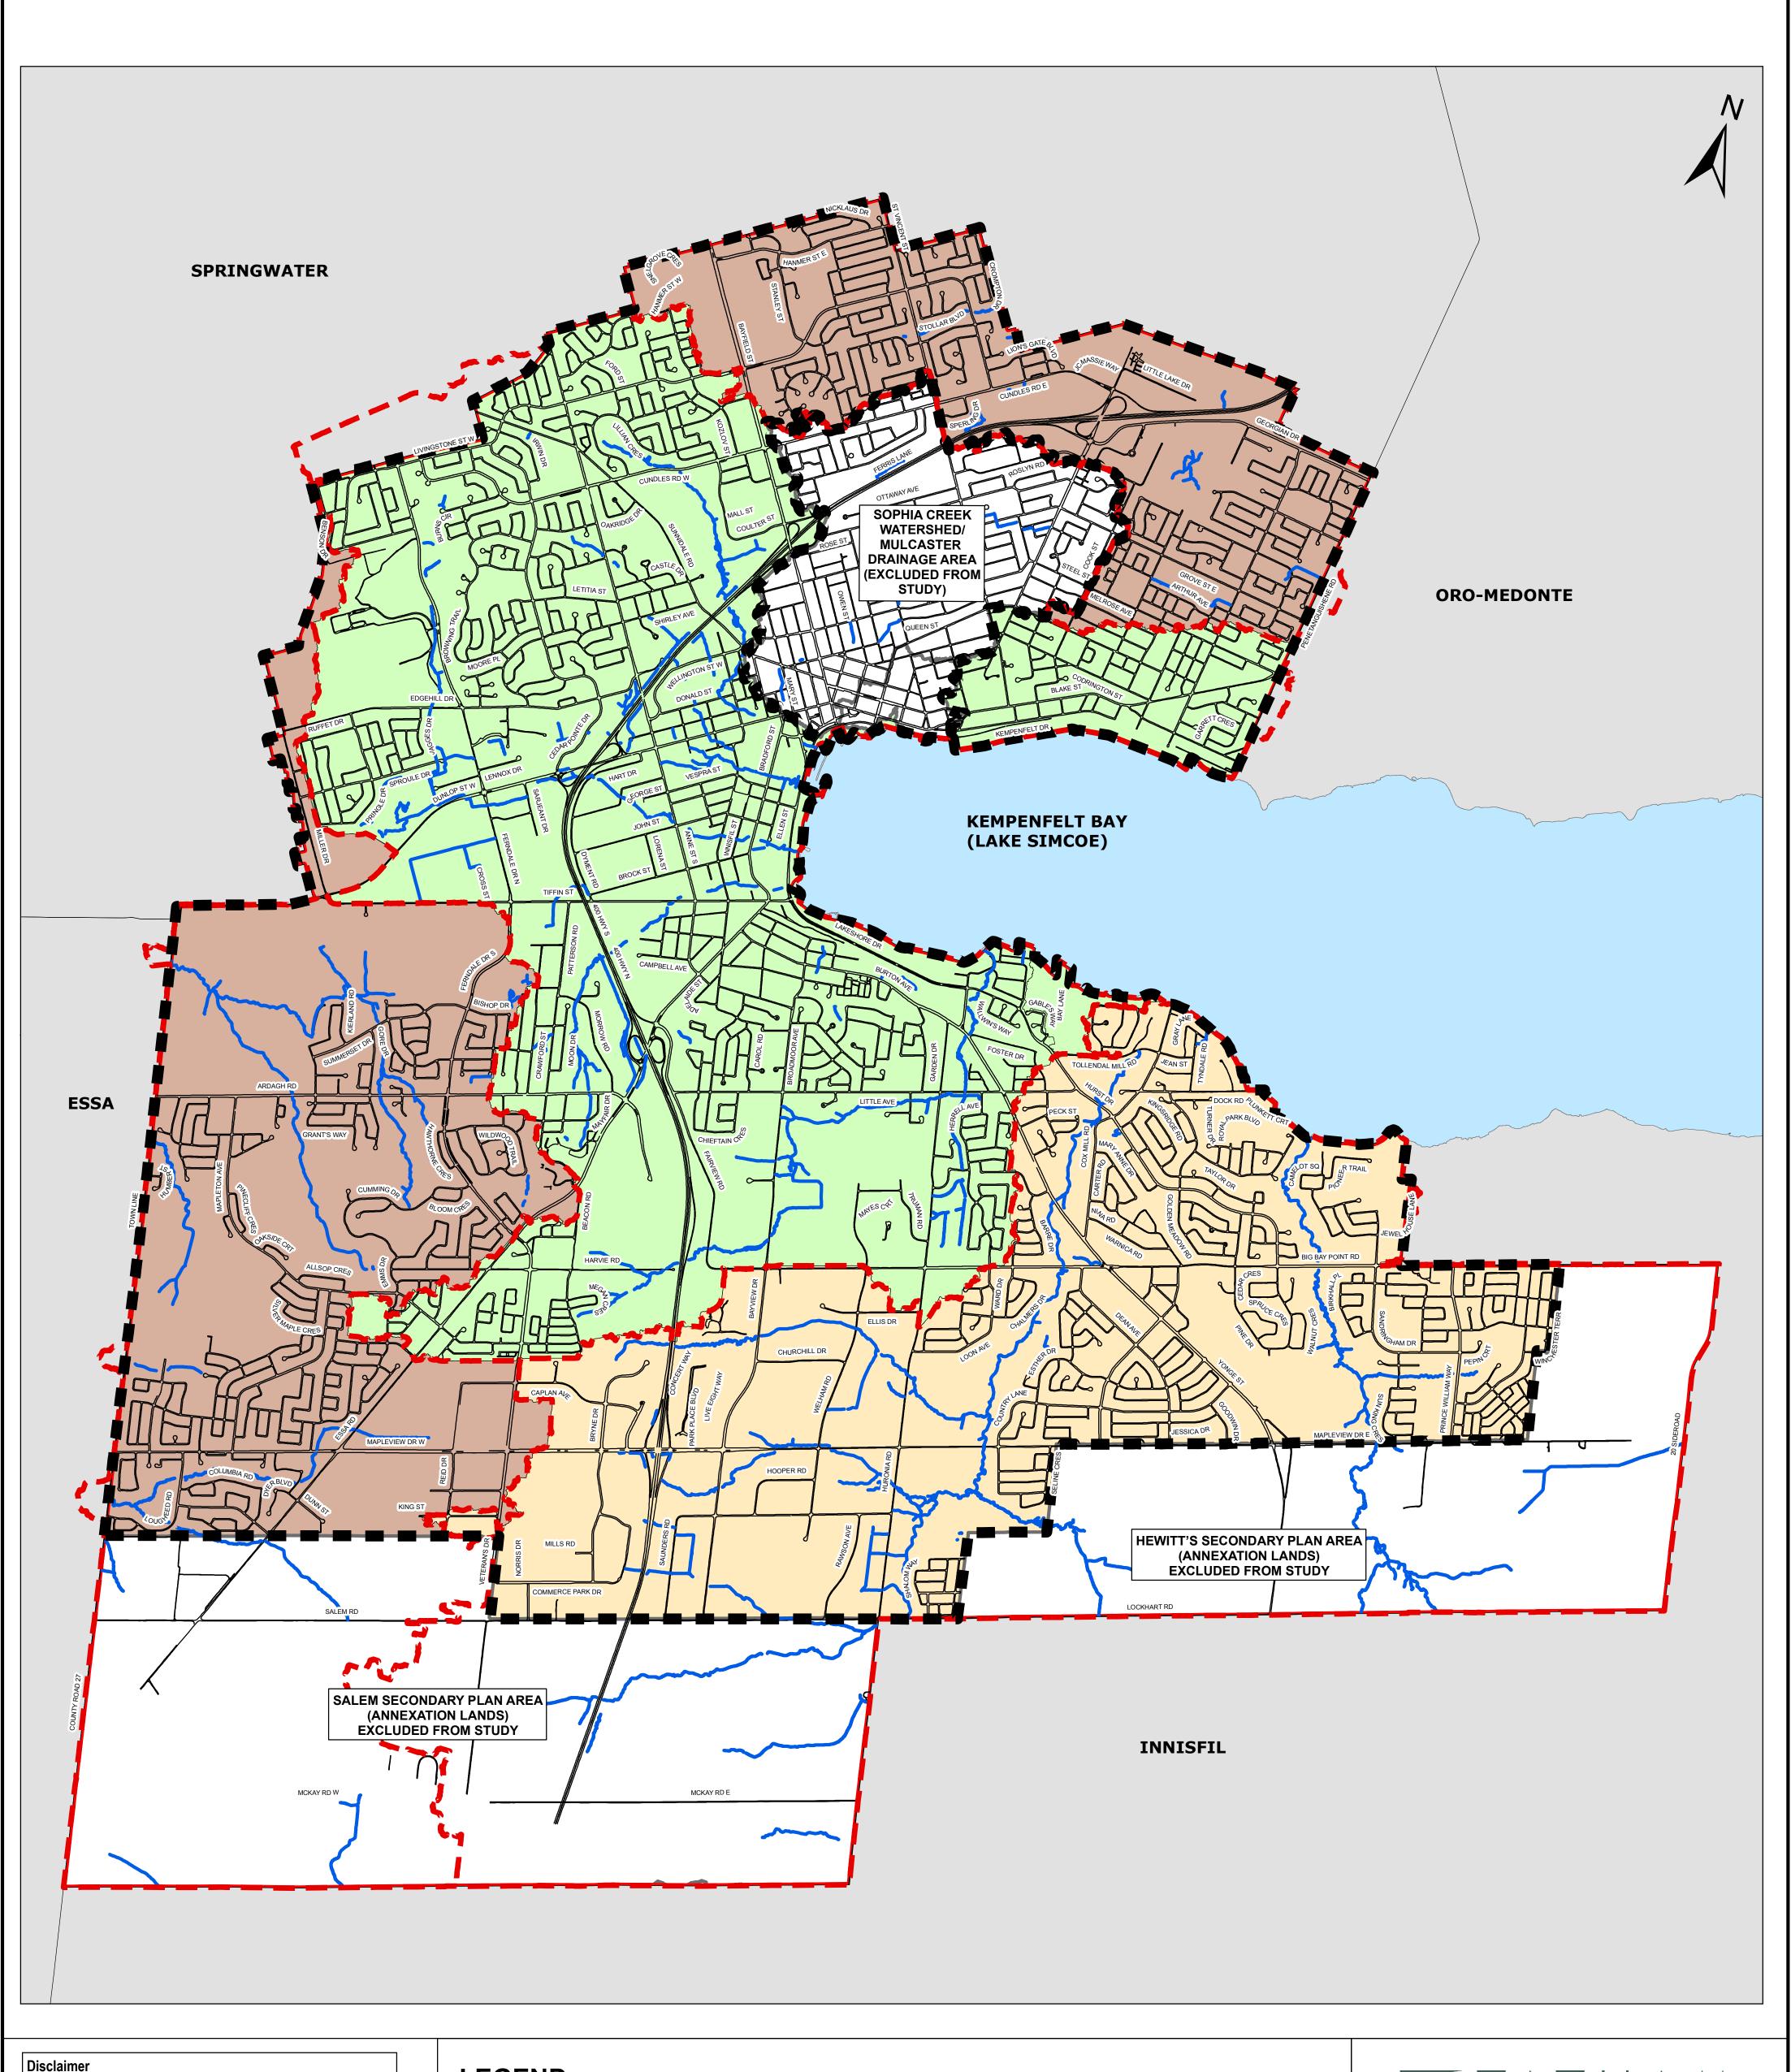
Appendix A: Figures



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LEGEND NVCA WATERSHED DRAINAGE STUDY ----- ROADS AREA **—** WATERCOURSES BARRIE CREEKS DRAINAGE STUDY AREA — DRAINAGE STUDY AREA BOUNDARY LOVERS CREEK AND HEWITTS CREEK ■ OVERALL STUDY AREA DRAINAGE STUDY AREA SOPHIA CREEK WATERSHED AND MUNICIPAL BORDER MULCASTER DRAINAGE AREA (EXCLUDED FROM STUDY) ANNEXATION LANDS

(EXCLUDED FROM STUDY)


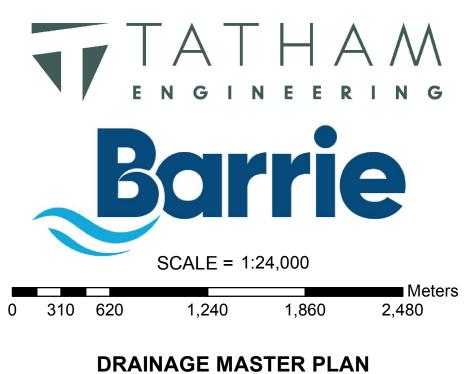


FIGURE 1 - STUDY AREA LOCATION PLAN

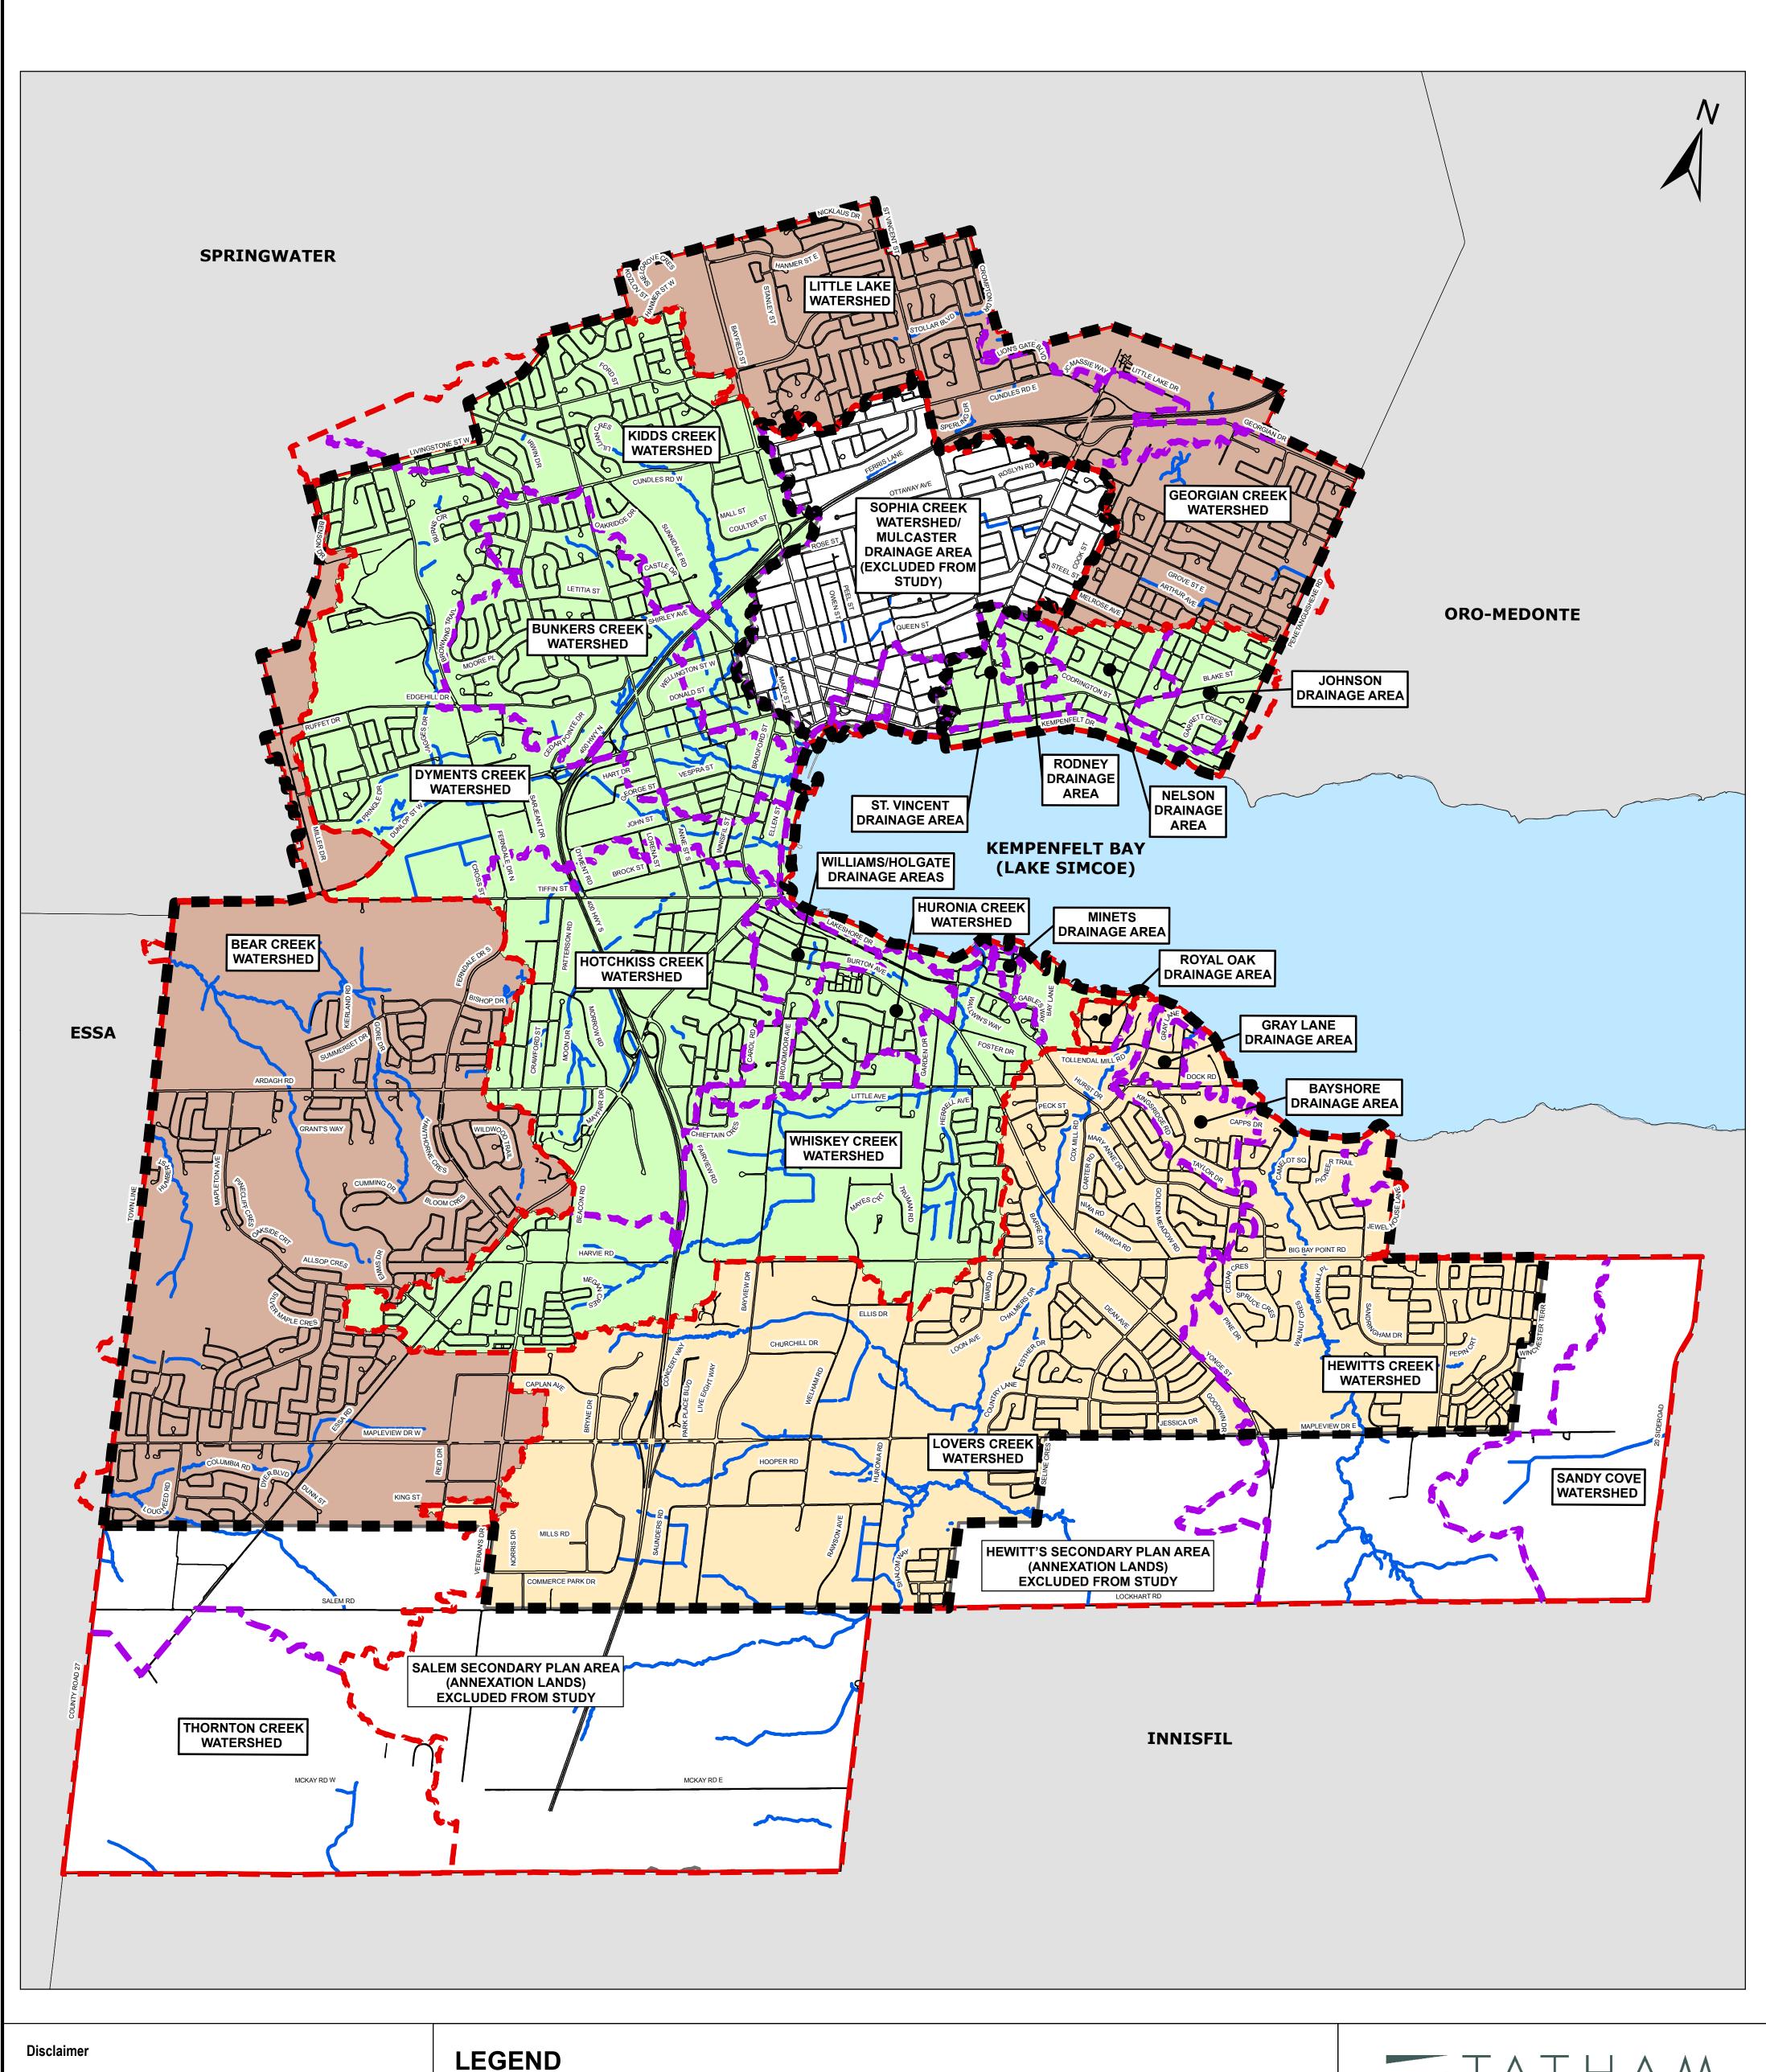

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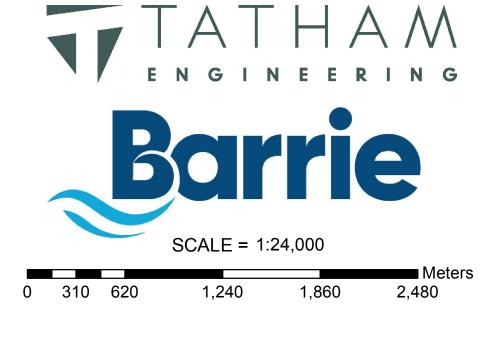
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ROADS WATERCOURSES DRAINAGE STUDY AREA BOUNDARY WATERSHED BOUNDARY WATERSHED BOUNDARY OVERALL STUDY AREA MUNICIPAL BORDER

MULCASTER DRAINAGE AREA (EXCLUDED FROM STUDY)

SOPHIA CREEK WATERSHED AND


ANNEXATION LANDS (EXCLUDED FROM STUDY)




DRAINAGE MASTER PLAN

FIGURE 2 - WATERSHED/DRAINAGE AREA DELINEATION PLAN

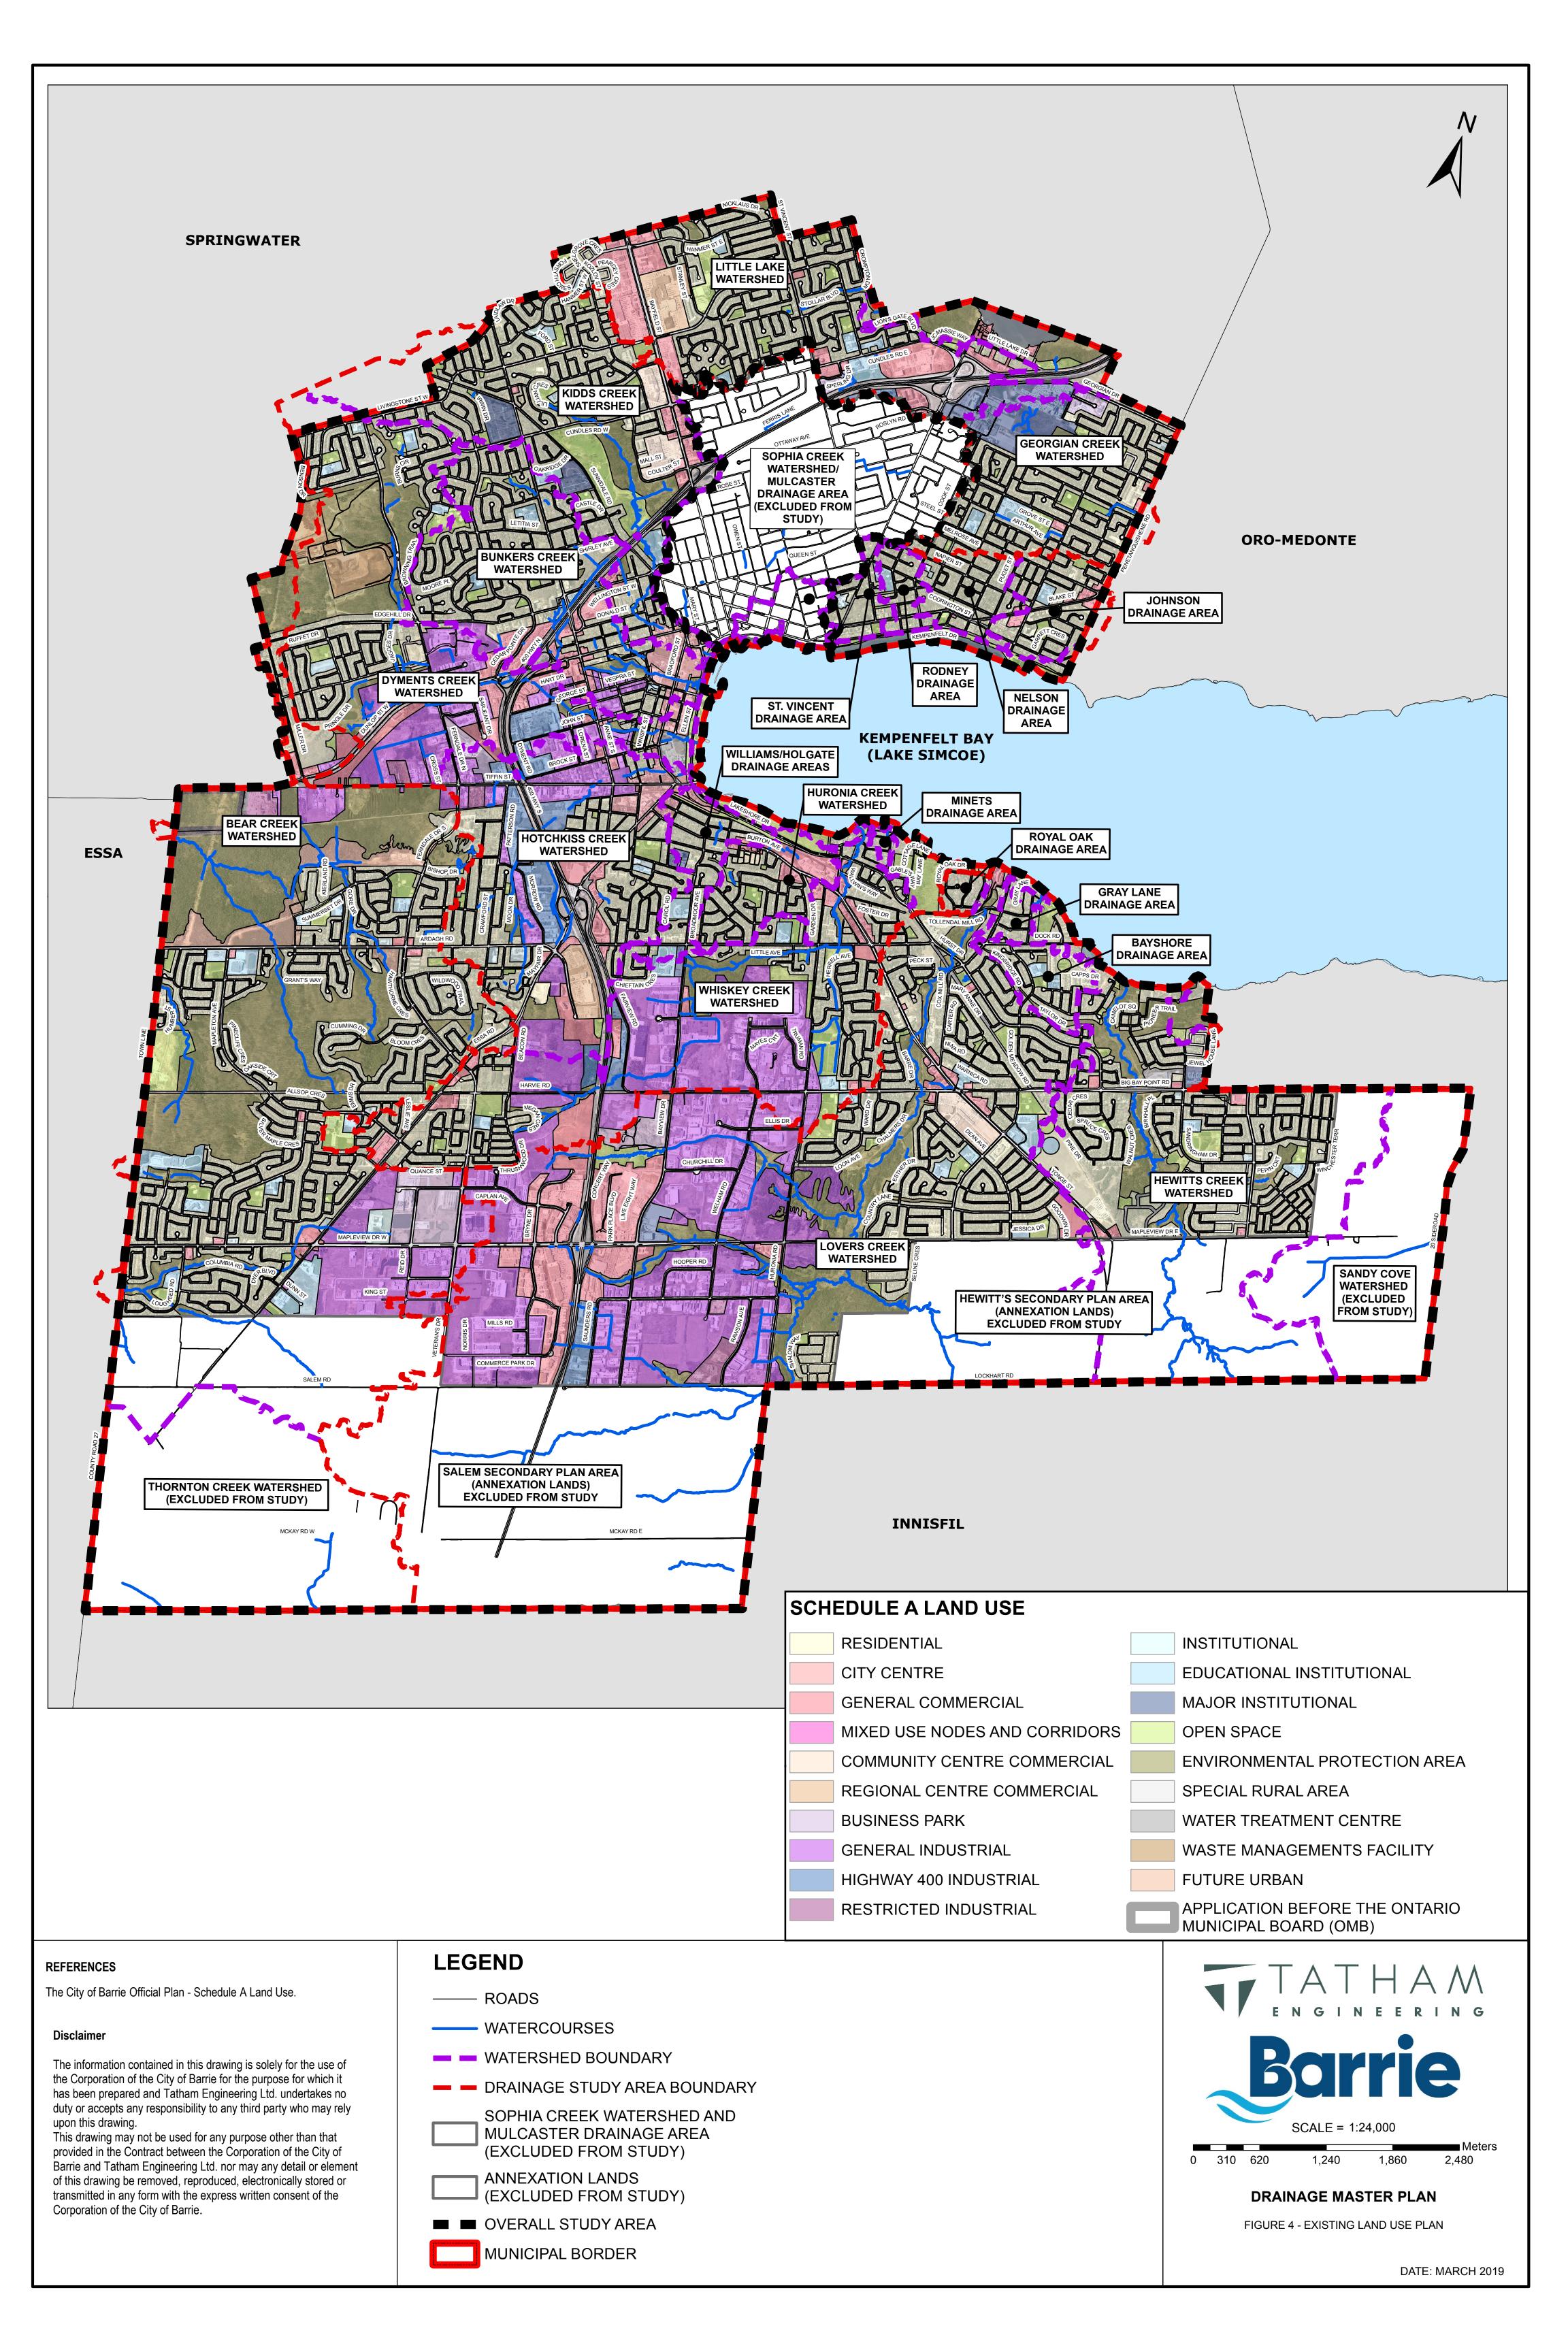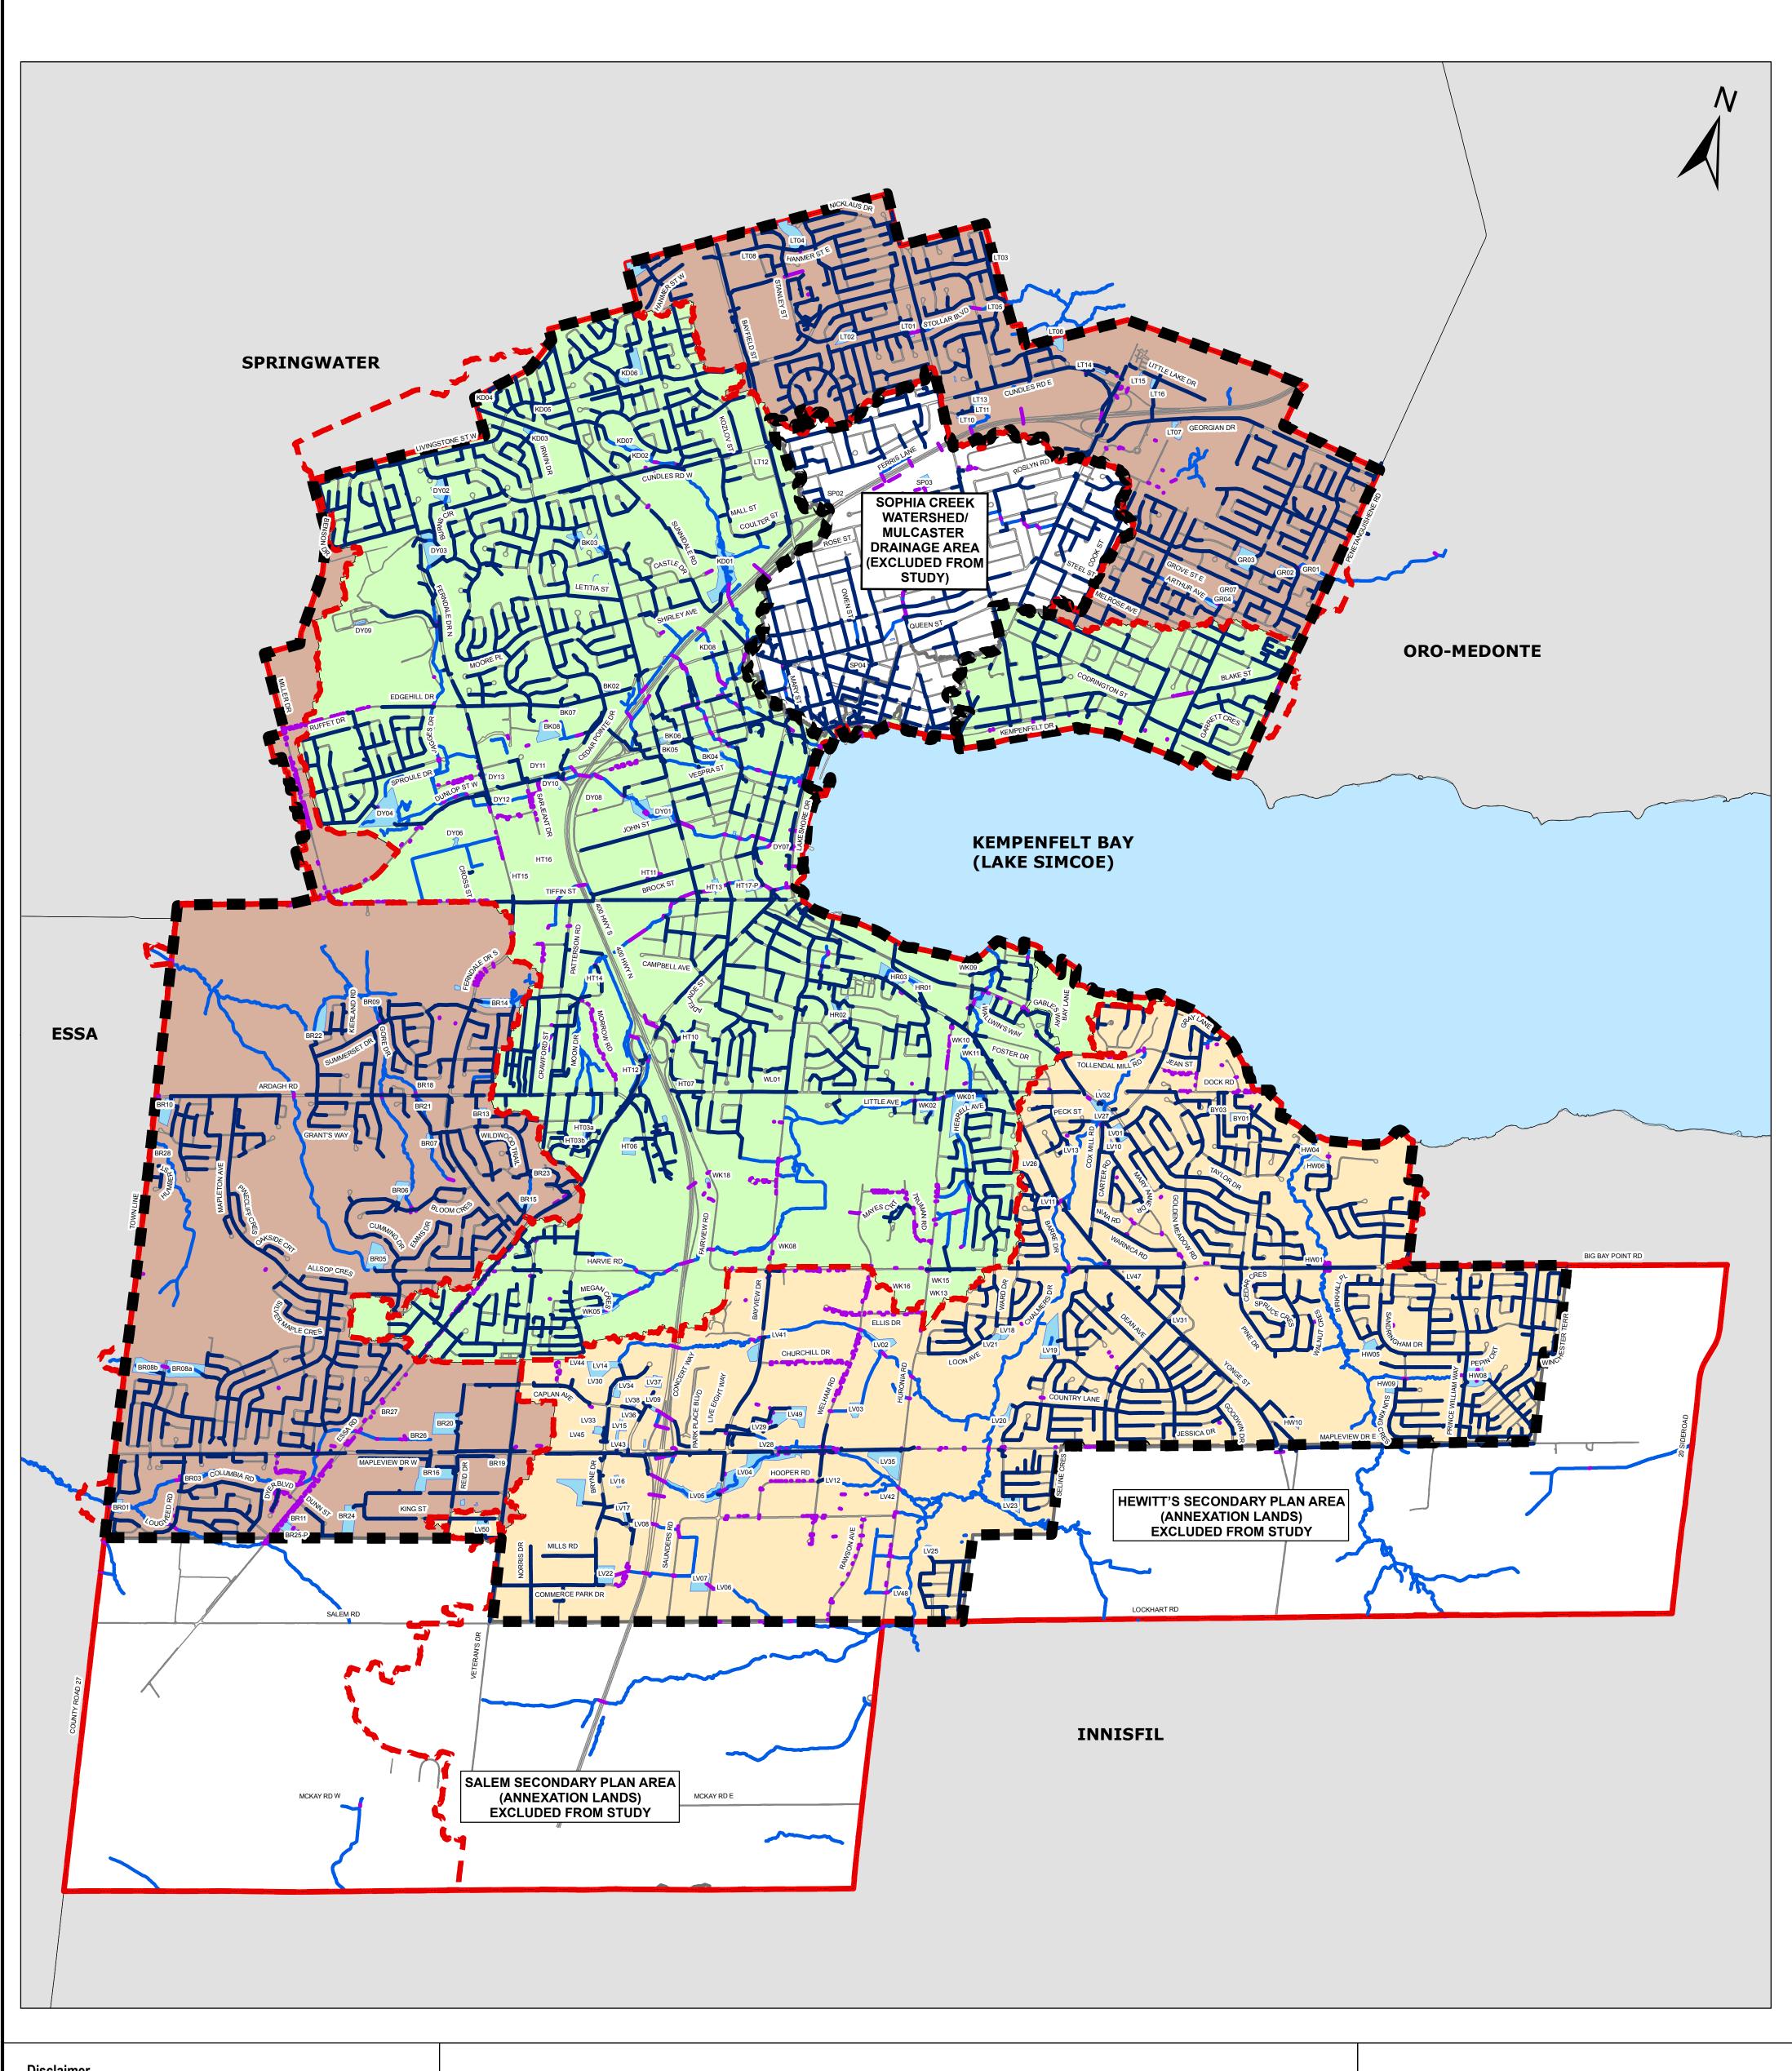Kidd's Creek **Hotchkiss Creek Whiskey Creek Dyments Creek** 1 Floodway Conveyance Capacity Improvements (Regional Storm) 48 New SWMF 65 SWMF Retrofit 27 Floodway Conveyance Capacity Improvements (Regional Storm) 2 Conveyance Capacity Improvements (Regional Storm) 66 SWMF Retrofit 28 Lakeshore Drive Culvert Improvements (Regional storm capacity) 49 New SWMF Toronto Street Culvert Improvements (1:100 year capacity) 29 Hart Drive Culvert Improvements (Regional storm capacity) 50 New SWMF 68 Harvie Road Culvert Improvements (1:100 year capacity) Donald Street Culvert Improvements (1:100 year capacity) 30 Highway 400 Culvert Improvements (Regional storm capacity) 51 SWMF Retrofit 69 Harvie Road Culvert Improvements (1:100 year capacity) Ross Street / Wellington Street Culvert Improvements (1:100 year capacity) 31 Floodway Conveyance Capacity Improvements (Regional Storm) 52 Outlet Channel Improvements (1:100 year capacity) 70 Highway 400 Culvert Improvements (1:100 year capacity) Cundles Road West Culvert Improvements (1:100 year capacity) 32 Floodway Conveyance Capacity Improvements (Regional Storm) 53 Lakeshore Drive Culvert Improvements (1:100 year capacity) 71 Fairview Drive Culvert Improvements (1:100 year capacity) Toronto Street to Simcoe Street Channel Improvements (1:100 year capacity) 33 Sanford Street Culvert Improvements (1:100 year capacity) 54 Bradford Street Culvert Improvements (1:100 year capacity) 72 BCR Culvert Improvements (1:100 year capacity) Dunlop Street to Eccles Street Channel Improvements (1:100 year capacity) 34 Innisfil Street Culvert Improvements (1:100 year capacity) 55 Innisfil Street Culvert Improvements (1:100 year capacity) 73 Bayview Drive Culvert Improvements (1:100 year capacity) Channel Improvements Upstream of Eccles Street (1:100 year capacity) 56 Anne Street Culvert Improvements (1:100 year capacity) 74 Bayview Drive Culvert Improvements (1:100 year capacity) 35 Anne Street / John Street Culvert Improvements (1:100 year capacity) 10 Channel Improvements Upstream of Eccles Street North (1:100 year capacity) 36 Victoria Street Culvert Improvements (1:100 year capacity) 57 Tiffin Street Culvert Improvements (1:100 year capacity) 75 McConkey Place Culvert Improvements (1:100 year capacity) 11 Simcoe Street to Dunlop Street Culvert Improvements (1:100 year capacity) 76 BCR Culvert Improvements (1:100 year capacity) 37 George Street Culvert Improvements (1:100 year capacity) 58 BCR Culvert Improvements (1:100 year capacity) 12 Culvert Improvements Upstream of Eccles Street (1:100 year capacity) 38 Sarjeant Street Culvert Improvements (1:100 year capacity) 59 Wood Street Culvert Improvements (1:100 year capacity) 77 Huronia Road Culvert Improvements (1:100 year capacity) 13 Bradford Street Spill Containment Improvements 39 Ferndale Drive North Culvert Improvements (1:100 year capacity) 60 Highway 400 Culvert Improvements (1:100 year capacity) 78 Little Avenue Culvert Improvements (1:100 year capacity) 14 Ross Street Spill Containment Improvements 40 Dunlop Street West Culvert Improvements (1:100 year capacity) 61 Morrow Road Culvert Improvements (1:100 year capacity) 79 Yonge Street Culvert Improvements (1:100 year capacity) 15 Highway 400 Spill Containment Improvements 41 SWMF Retrofit Tollendal Mill Road Culvert Improvements (1:100 year capacity) 62 W.P.C.C. Channel Improvements (1:100 year capacity) 42 SWMF Retrofit 81 The Boulevard Culvert Improvements (1:100 year capacity) **Bunkers Creek** 63 Essa Road Trunk Storm Sewer Improvements (1:100 year capacity) 64 Gowan Street Trunk Storm Sewer Improvements (1:100 year capacity) 43 New SWMF Brennan Avenue Culvert Improvements (1:100 year capacity) 16 New SWMF and Storm Sewer Diversion to SWMF 17 Lakeshore Drive Culvert Improvements (1:100 year capacity) 44 Ferndale Drive North to Sarjeant Drive Channel Improvements (1:100 year capacity) 83 279 Bayview Drive Channel Improvements (1:100 year capacity) 45 Dunlop Street West to Ferndale Drive North Channel Improvements (1:100 year capacity) 18 Bradford Street Culvert Improvements (1:100 year capacity) 84 Channel Improvements Downstream of Huronia Road (1:100 year capacity) 46 Channel Improvements Upstream of Dunlop Street (1:100 year capacity) 19 Innisfil Street Culvert Improvements (1:100 year capacity) 85 Little Avenue to Yonge Street Channel Improvements (1:100 year capacity) 86 The Boulevard to Brennan Avenue Channel Improvements (1:100 year capacity) 20 Highway 400 North Branch Culvert Improvements (1:100 year capacity) 47 Channel Improvements Downstream of Sproule Drive (1:100 year capacity) 95 Bradford Street Culvert Improvements (Regional Conveyance) 21 Highway 400 Central Branch Culvert Improvements (1:100 year capacity) 87 Brennan Avenue to Kempenfelt Bay Channel Improvements (1:100 year capacity) 22 Highway 400 South Branch Culvert Improvements (1:100 year capacity) **Nelson & Johnson Drainage Area** 23 Anne Street to Highway 400 Trunk Storm Sewer Improvements (1:100 year capacity) 88 Varden Crescent Drainage Issue Improvement Area 24 North Branch Trunk Storm Sewer Improvements (1:100 year capacity) 89 Oliver Street/Alexander Avenue Drainage Issue Improvement Area 25 Natural Watercourse Enhancements From Kempenfelt Bay to Bradford Street 90 Indian Arrow Road Near Johnson Street Drainage Issue Improvement Area 26 Milligan's Pond Improvements 91 Blake Street Drainage Issue Improvement Area 92 36 Shanty Bay Road Drainage Issue Improvement Area 93 Puget Street Drainage Issue Improvement Area NOTE: PROJECTS COMPLETED SINCE ADOPTION OF MASTER DRAINAGE PLANS ARE IDENTIFIED IN GREEN. 94 Shanty Bay Road Drainage Issue Improvement Area **SPRINGWATER** KIDDS CREEK **WATERSHED** 6 GEORGIAN CREEK **SOPHIA CREEK** WATERSHED WATERSHED (EXCLUDED FROM STUDY) **BUNKERS CREEK** WATERSHED NELSON DRAINAGE **AREA JOHNSON DRAINAGE AREA RODNEY** MULCASTER **DRAINAGE** DRAINAGE AREA ST. VINCENT **AREA** DRAINAGE AREA (EXCLUDED FROM STUDY) DYMENTS CREEK **WATERSHED KEMPENFELT BAY** WILLIAMS/HOLGATE (LAKE SIMCOE) **DRAINAGE AREAS BEAR CREEK MINETS WATERSHED** DRAINAGE AREA **ROYAL OAK** HOTCHKISS CREEK **DRAINAGE AREA WATERSHED GRAY LANE** HURONIA CREEK DRAINAGE AREA **WATERSHED BAYSHORE DRAINAGE AREA** WHISKEY CREEK **WATERSHED** 70 LOVERS CREEK **WATERSHED REFERENCES LEGEND** Kidd's Creek Master Drainage Plan Class Environmental Assessment Report. Oliver, Mangione, McCalla& Associates (2001). PROPOSED IMPROVEMENT ID# **IMPLEMENTED SWMF** Bunkers Creek Master Drainage Plan Update. RETROFIT/CREATION Giffels Assoicates Limited (2001). IMPLEMENTED IMPROVEMENT ID# IMPLEMENTED CHANNEL/GRADING Dyments Creek Master Drainage Plan Municipal Class Environmental Assessment. ROADS The Jones Consulting Group (2004). **IMPROVEMENTS** WATERCOURSES Dyments Creek Master Drainage Plan Municipal Class Environmental Assessment - Final Revisions OVERALL STUDY AREA The City of Barrie (2006). Barrie CULVERTS — WATERSHED BOUNDARY Hotchkiss Creek Master Drainage Plan Update Environmental Assessment Document. R.G. Robinson and Associates Ltd. (2000). — DRAINAGE STUDY AREA BOUNDARY SOPHIA CREEK WATERSHED AND Whiskey Creek Master Drainage Plan Update Environmental Assessment Document. MULCASTER DRAINAGE AREA PROPOSED CULVERT/TRUNK SEWER Aecom (2009). **IMPROVEMENTS** (EXCLUDED FROM STUDY) SCALE = 1:14,000Hydrologic & Hydraulic Modeling and Drainage Study for the Nelson & Johnson Drainage Areas. Greenland International Consulting (2009). BARRIE CREEKS DRAINAGE STUDY PROPOSED SWMF RETROFIT/CREATION 0 180 360 720 1,080 1,440 **AREA** Disclaimer PROPOSED CHANNEL/GRADING The information contained in this drawing is solely for the use of the **NVCA WATERSHED DRAINAGE STUDY** DRAINAGE MASTER PLAN Corporation of the City of Barrie for the purpose for which it has been **IMPROVEMENTS** prepared and Tatham Engineering Ltd. undertakes no duty or accepts any **AREA** FIGURE 3 - PREVIOUS DRAINAGE IMPROVEMENT responsibility to any third party who may rely upon this drawing. IMPLEMENTED CULVERT/TRUNK SEWER This drawing may not be used for any purpose other than that provided in RECOMMENDATIONS FROM BACKGROUND LOVERS CREEK AND HEWITTS CREEK **IMPROVEMENTS** MASTER DRAINAGE PLANS the Contract between the Corporation of the City of Barrie and Tatham DRAINAGE STUDY AREA Engineering Ltd. nor may any detail or element of this drawing be removed, reproduced, electronically stored or transmitted in any form with the MUNICIPAL BORDER DATE: MARCH 2019 express written consent of the Corporation of the City of Barrie.





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LEGEND CULVERTS EXISTING STORM SEWER ROADS WATERCOURSES ■ OVERALL STUDY AREA DRAINAGE STUDY AREA BOUNDARY STORMWATER MANAGEMENT FACILITY (SWMF), ROOFTOP STORAGE, MECHANICAL DEVICES

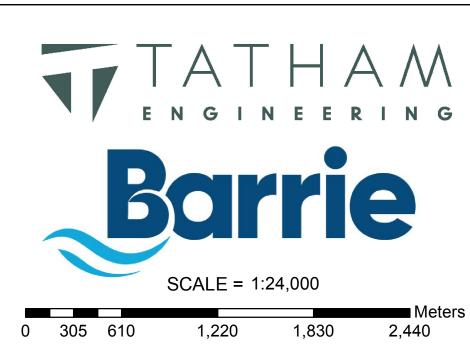
ANNEXATION LANDS (EXCLUDED FROM STUDY) SOPHIA CREEK AND MULCASTER

DRAINAGE AREAS (EXCLUDED FROM STUDY) NVCA WATERSHED DRAINAGE STUDY AREA

BARRIE CREEKS DRAINAGE STUDY AREA


LOVERS CREEK AND HEWITTS CREEK DRAINAGE STUDY AREA

MUNICIPAL BORDER



DRAINAGE MASTER PLAN

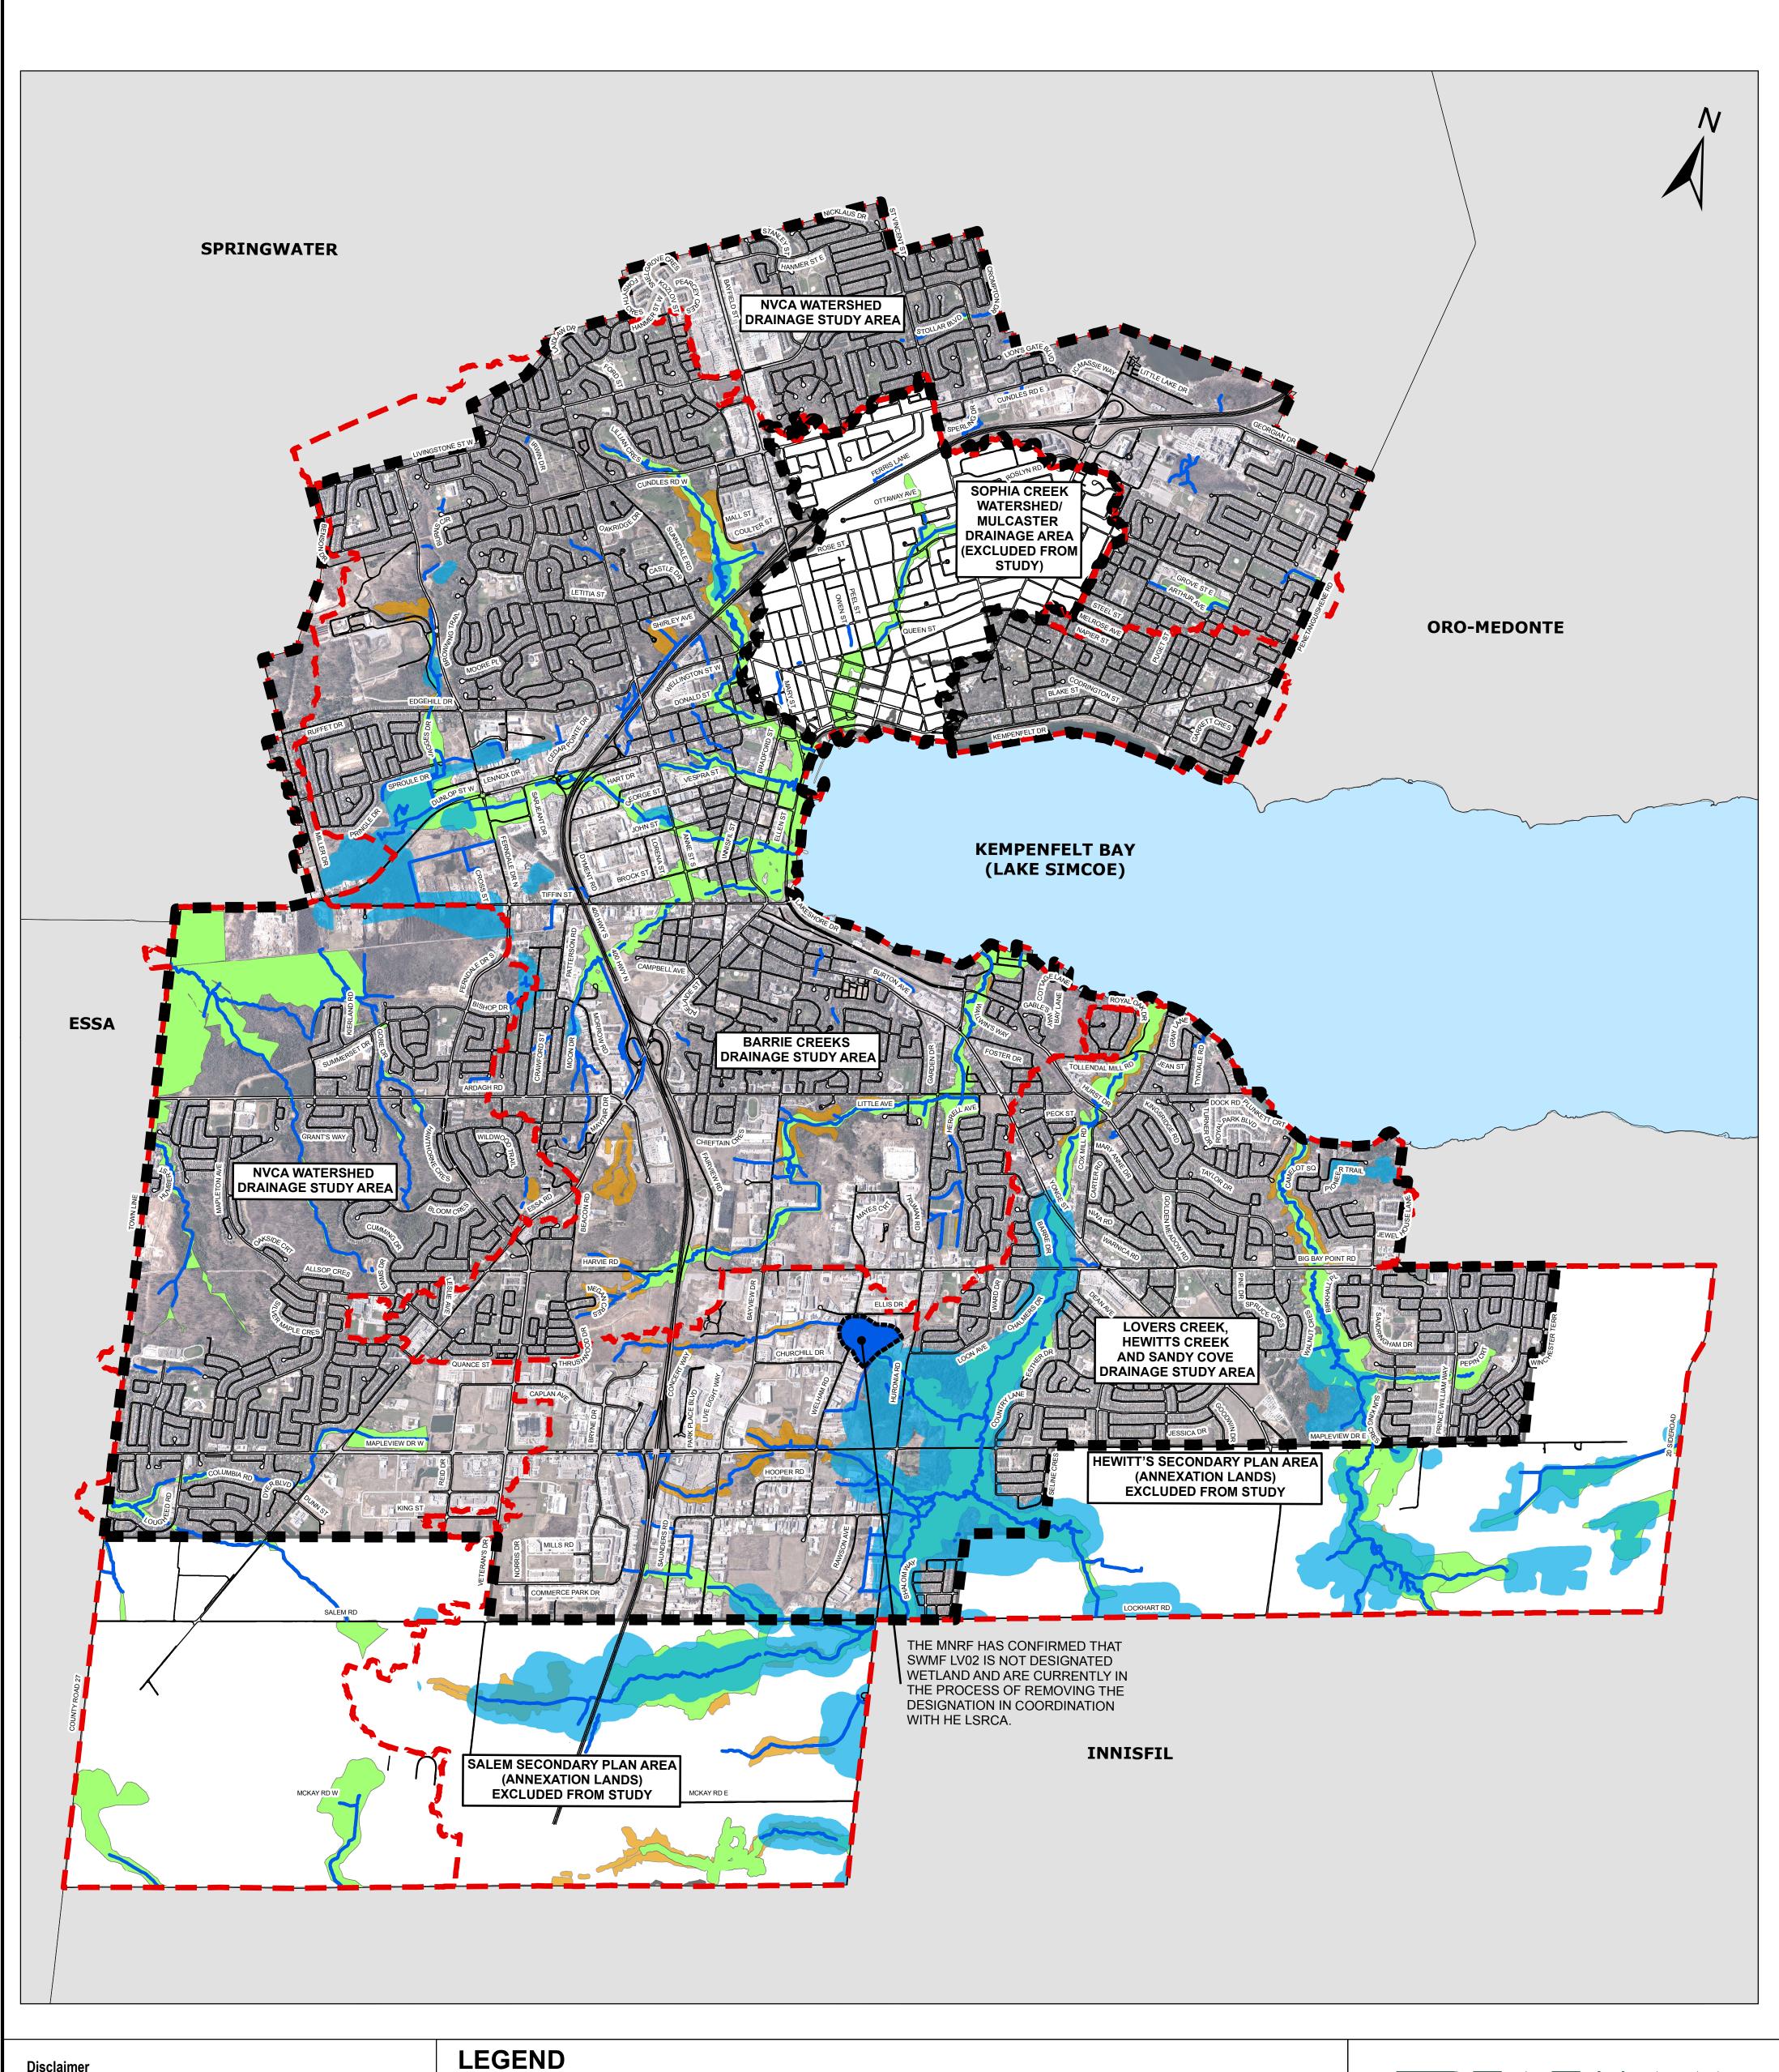FIGURE 5 - EXISTING STORMWATER MANAGEMENT INFRASTRUCTURE PLAN



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----- ROADS **—** WATERCOURSES — DRAINAGE STUDY AREA BOUNDARY ■ OVERALL STUDY AREA WETLAND **EROSION HAZARD** FLOODPLAIN HAZARD SOPHIA CREEK WATERSHED AND MULCASTER DRAINAGE AREA (EXCLUDED FROM STUDY) ANNEXATION LANDS (EXCLUDED FROM STUDY) MUNICIPAL BORDER



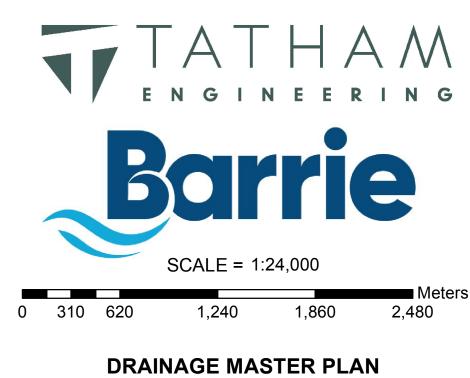


FIGURE 6 - NATURAL HAZARDS PLAN

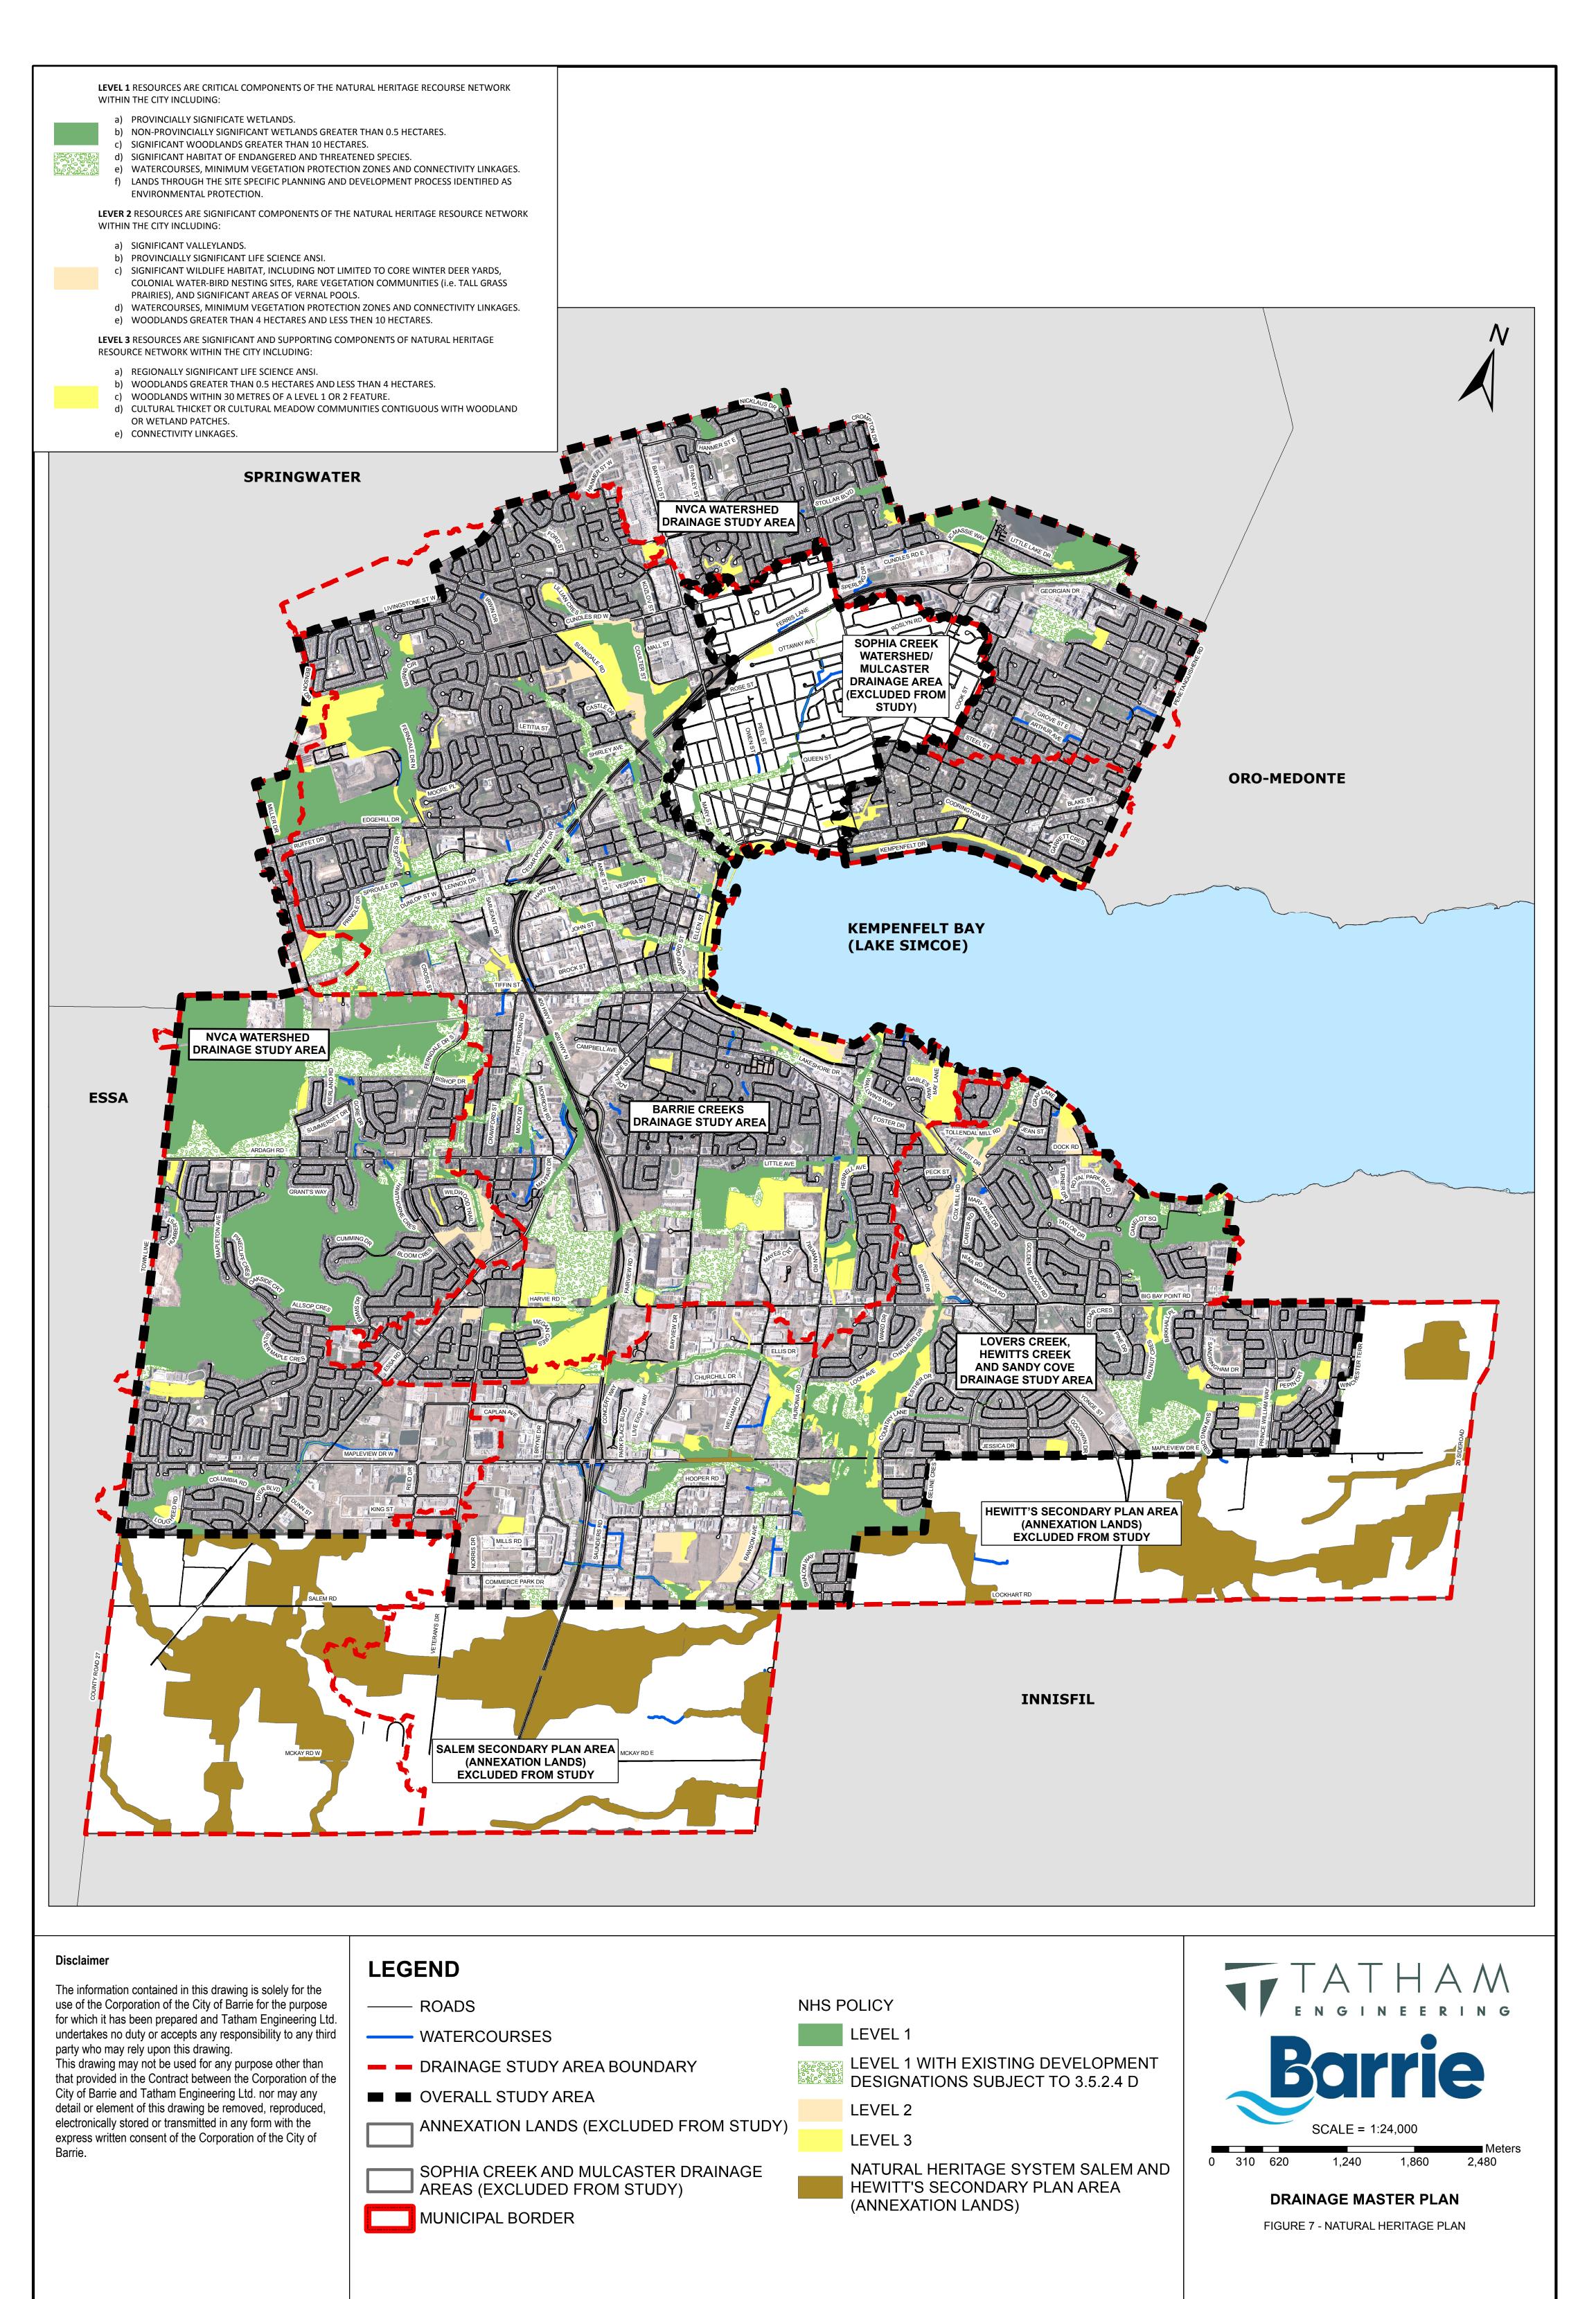

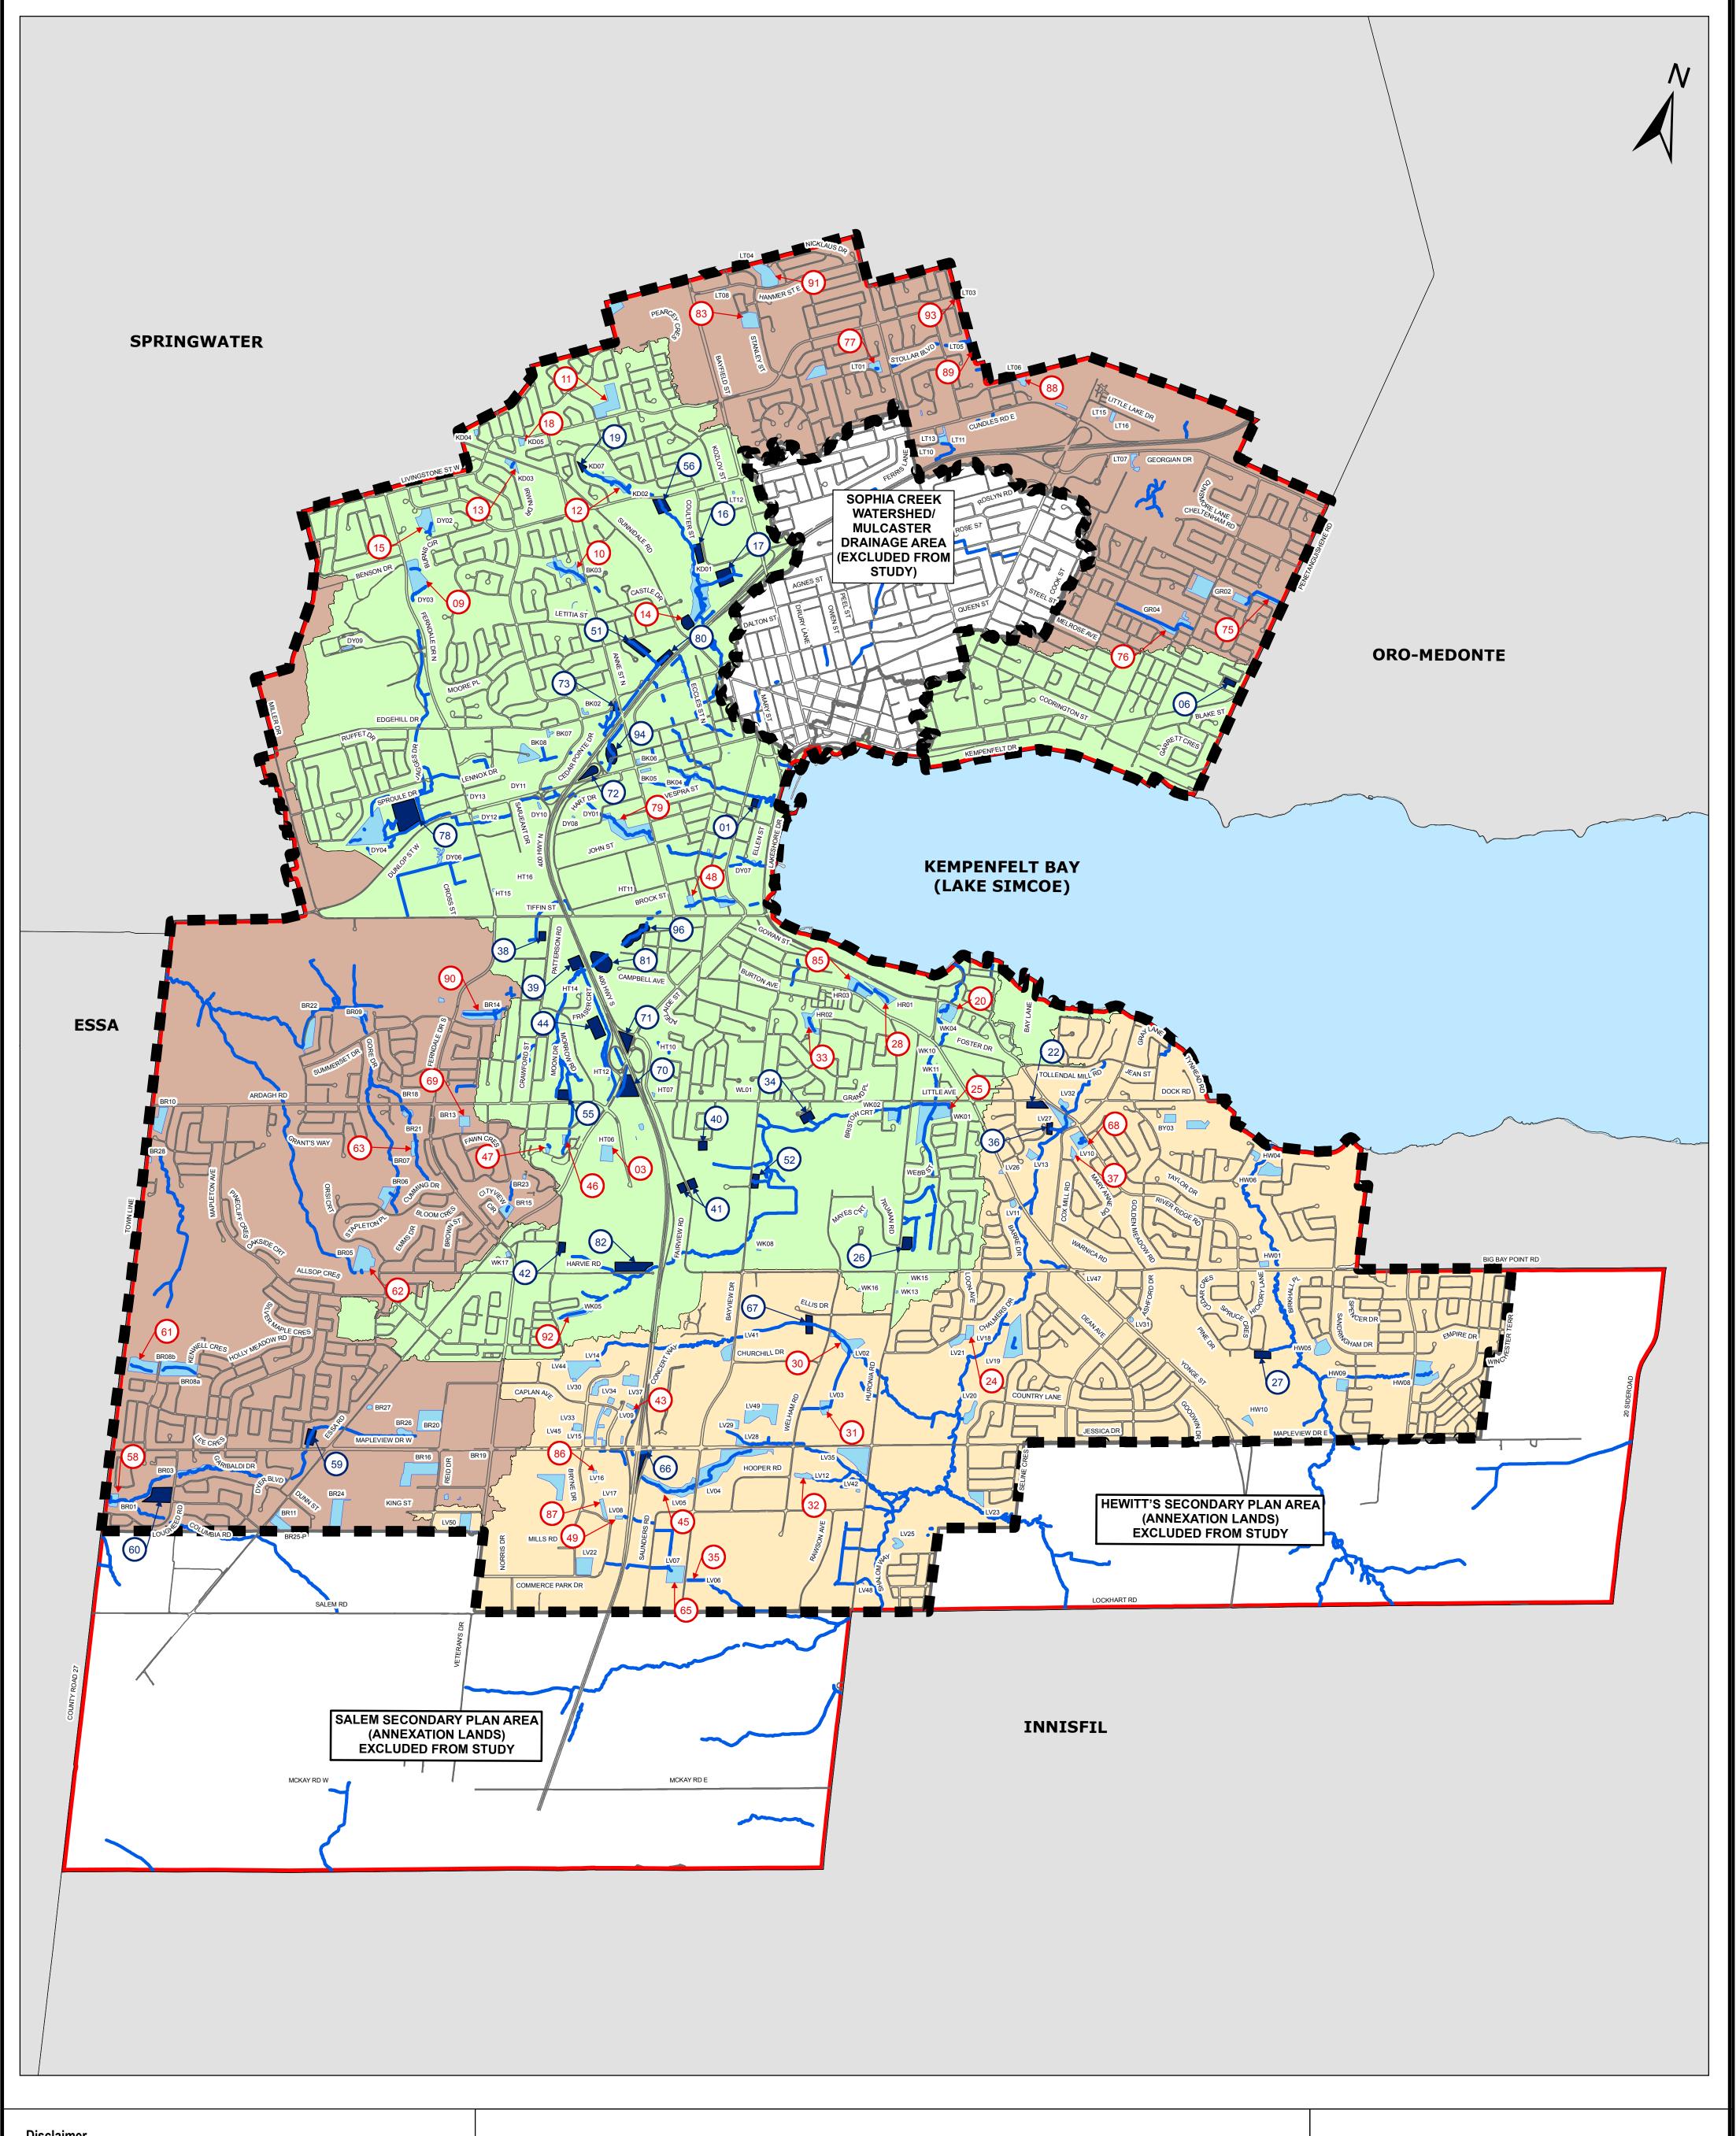

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LEGEND EXISTING SWMF RETROFIT OPPORTUNITY (OPPORTUNITY ID) NVCA WATERSHED DRAINAGE STUDY AREA PROPOSED SWMF (OPPORTUNITY ID) BARRIE CREEKS DRAINAGE STUDY AREA ROADS LOVERS CREEK AND HEWITTS CREEK WATERCOURSE DRAINAGE STUDY AREA ■ OVERALL STUDY AREA MUNICIPAL BORDER 0 310 620 PROPOSED SWMF **EXISTING SWMF** FIGURE 8 - SWMF RETROFIT/CREATION OPPORTUNITIES ANNEXATION LANDS (EXCLUDED FROM STUDY) SOPHIA CREEK WATERSHED AND MULCASTER DRAINAGE AREA

(EXCLUDED FROM STUDY)

Barrie

1,860

2,480

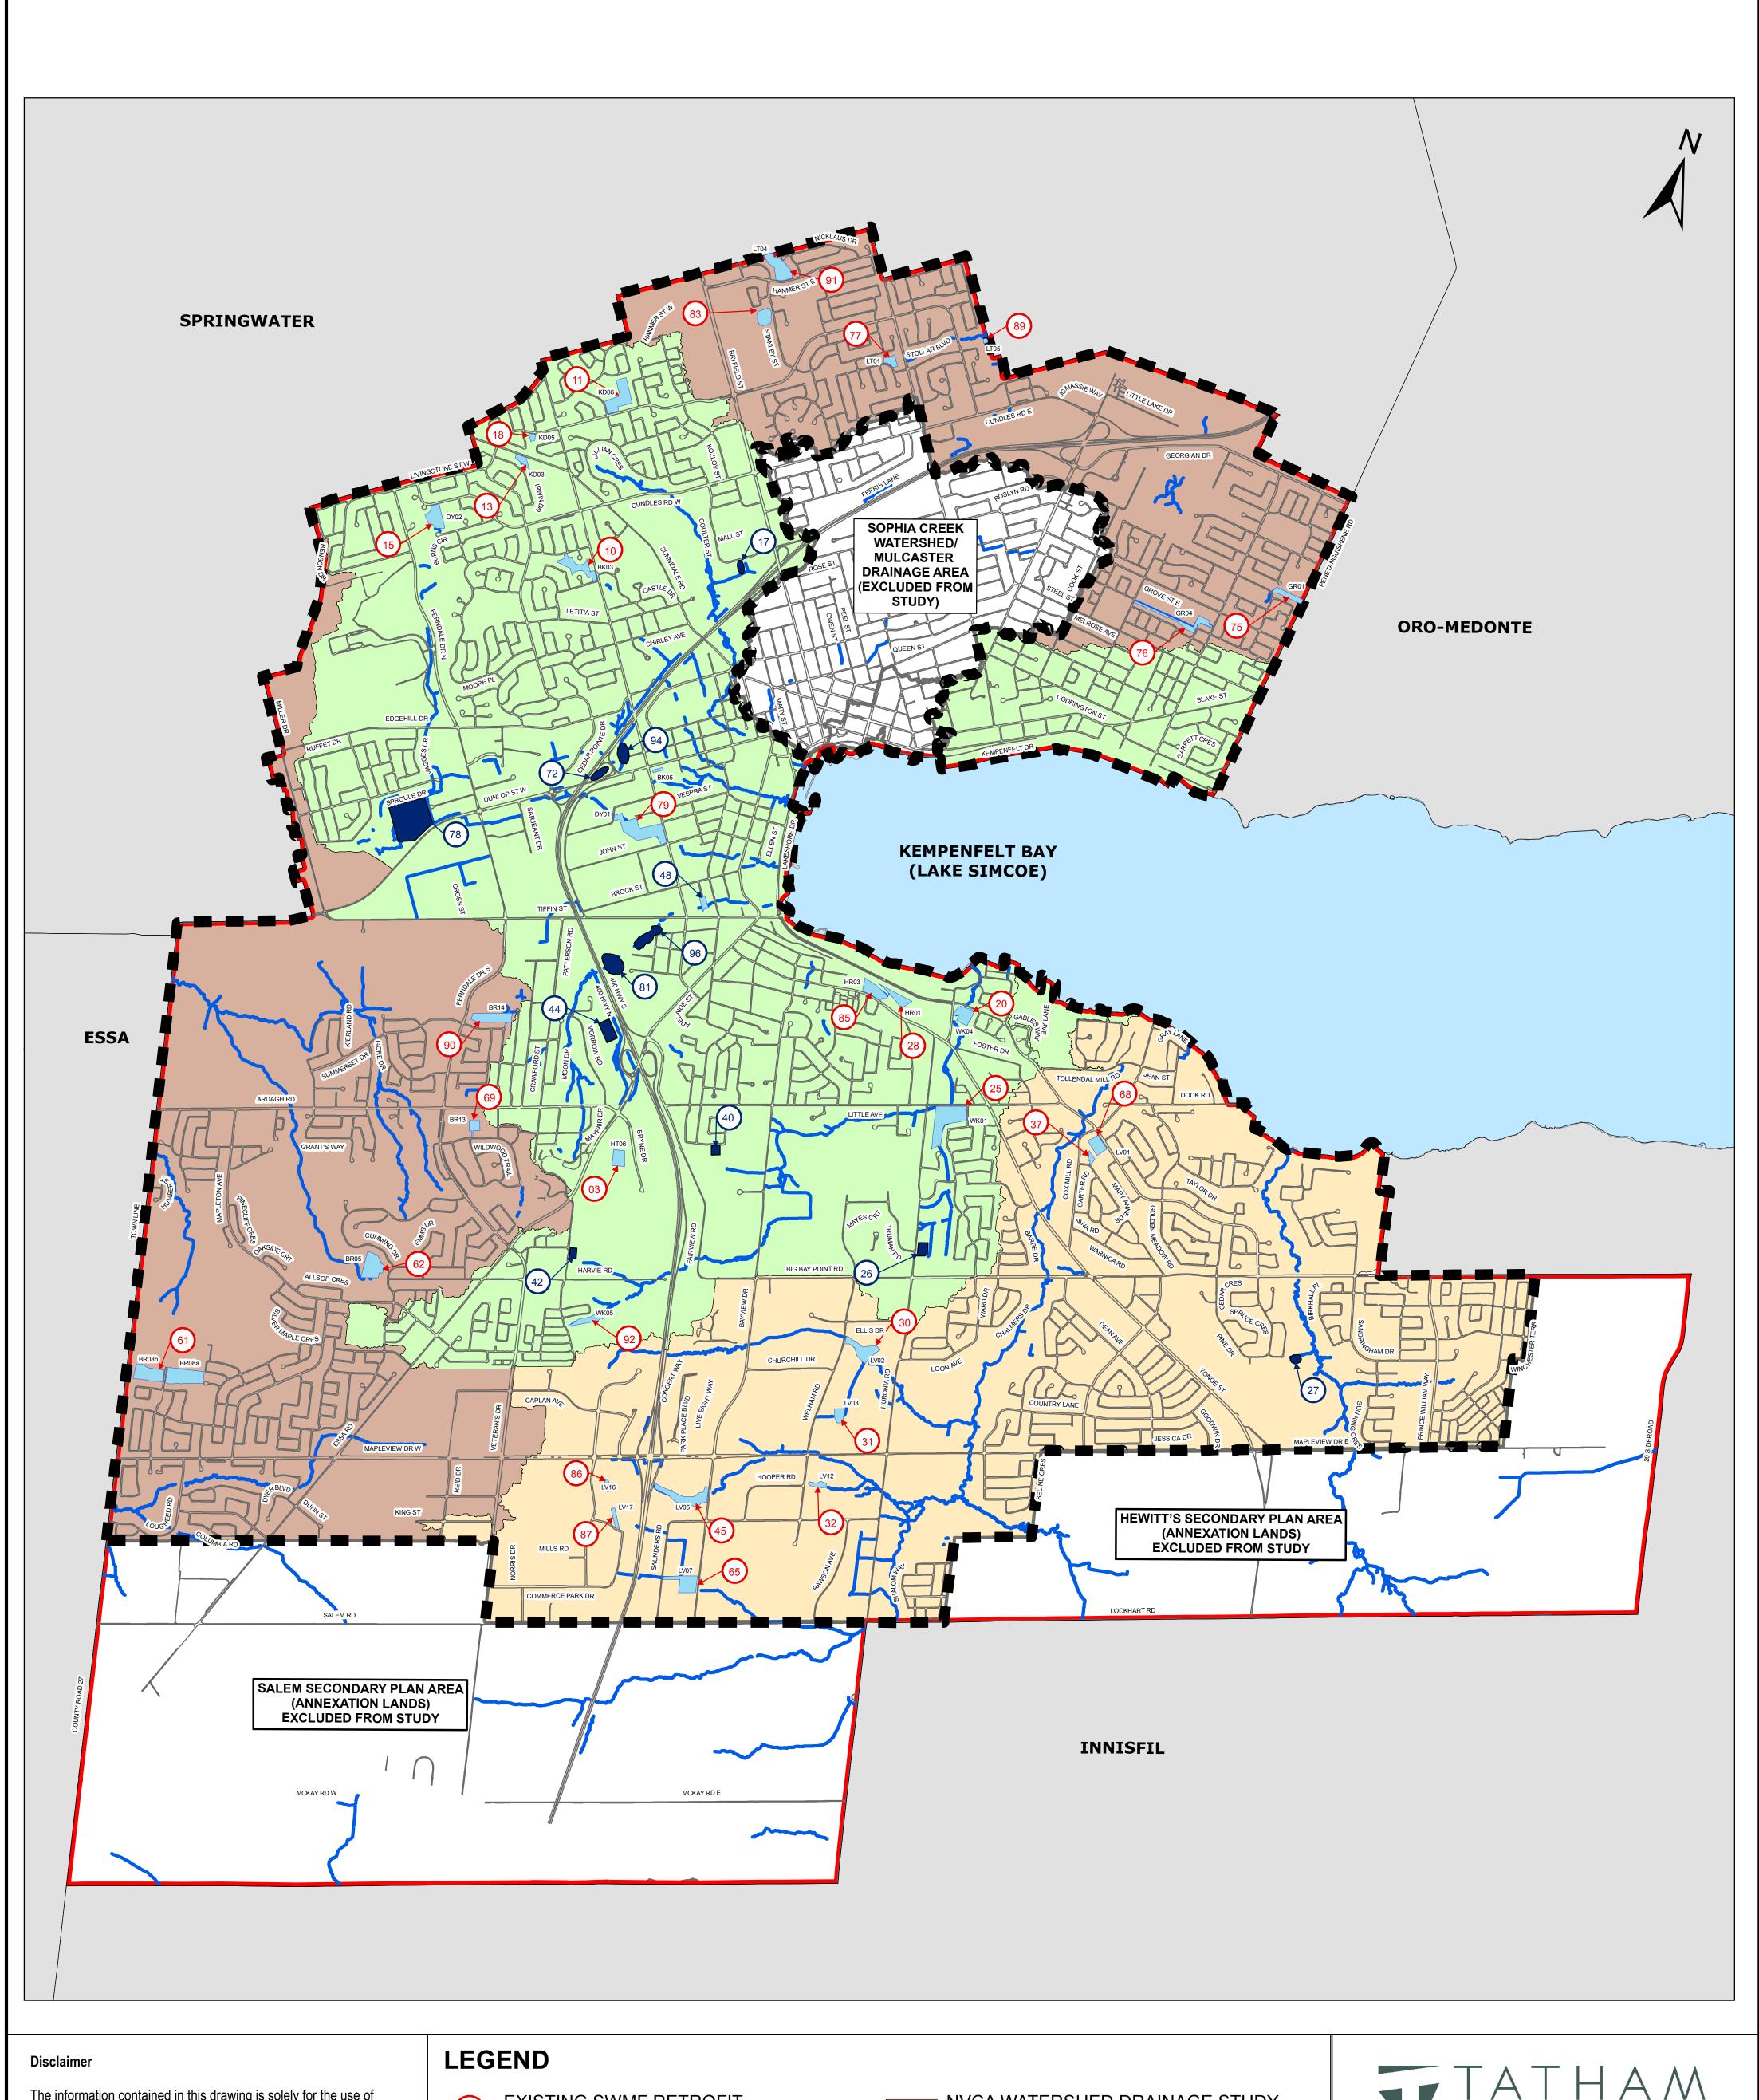
DATE: MARCH 2019

SCALE = 1:24,000

DRAINAGE MASTER PLAN

(PRE-SCREENING EVALUATION)

1,240



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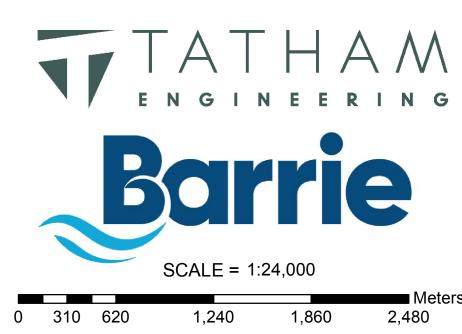
LEGEND SEXISTING SWMF RETROFIT OPPORTUNITY ID) PROPOSED SWMF CREATION OPPORTUNITY (OPPORTUNITY ID) ROADS WATERCOURSE WATERCOURSE PROPOSED SWMF EXISTING SWMF EXISTING SWMF BARRIE CREEKS DRAINAGE STUDY AREA DVERALL STUDY AREA MUNICIPAL BORDER EXISTING SWMF

ANNEXATION LANDS (EXCLUDED FROM

MULCASTER DRAINAGE AREA (EXCLUDED FROM STUDY)


SOPHIA CREEK WATERSHED AND

STUDY)



DRAINAGE MASTER PLAN

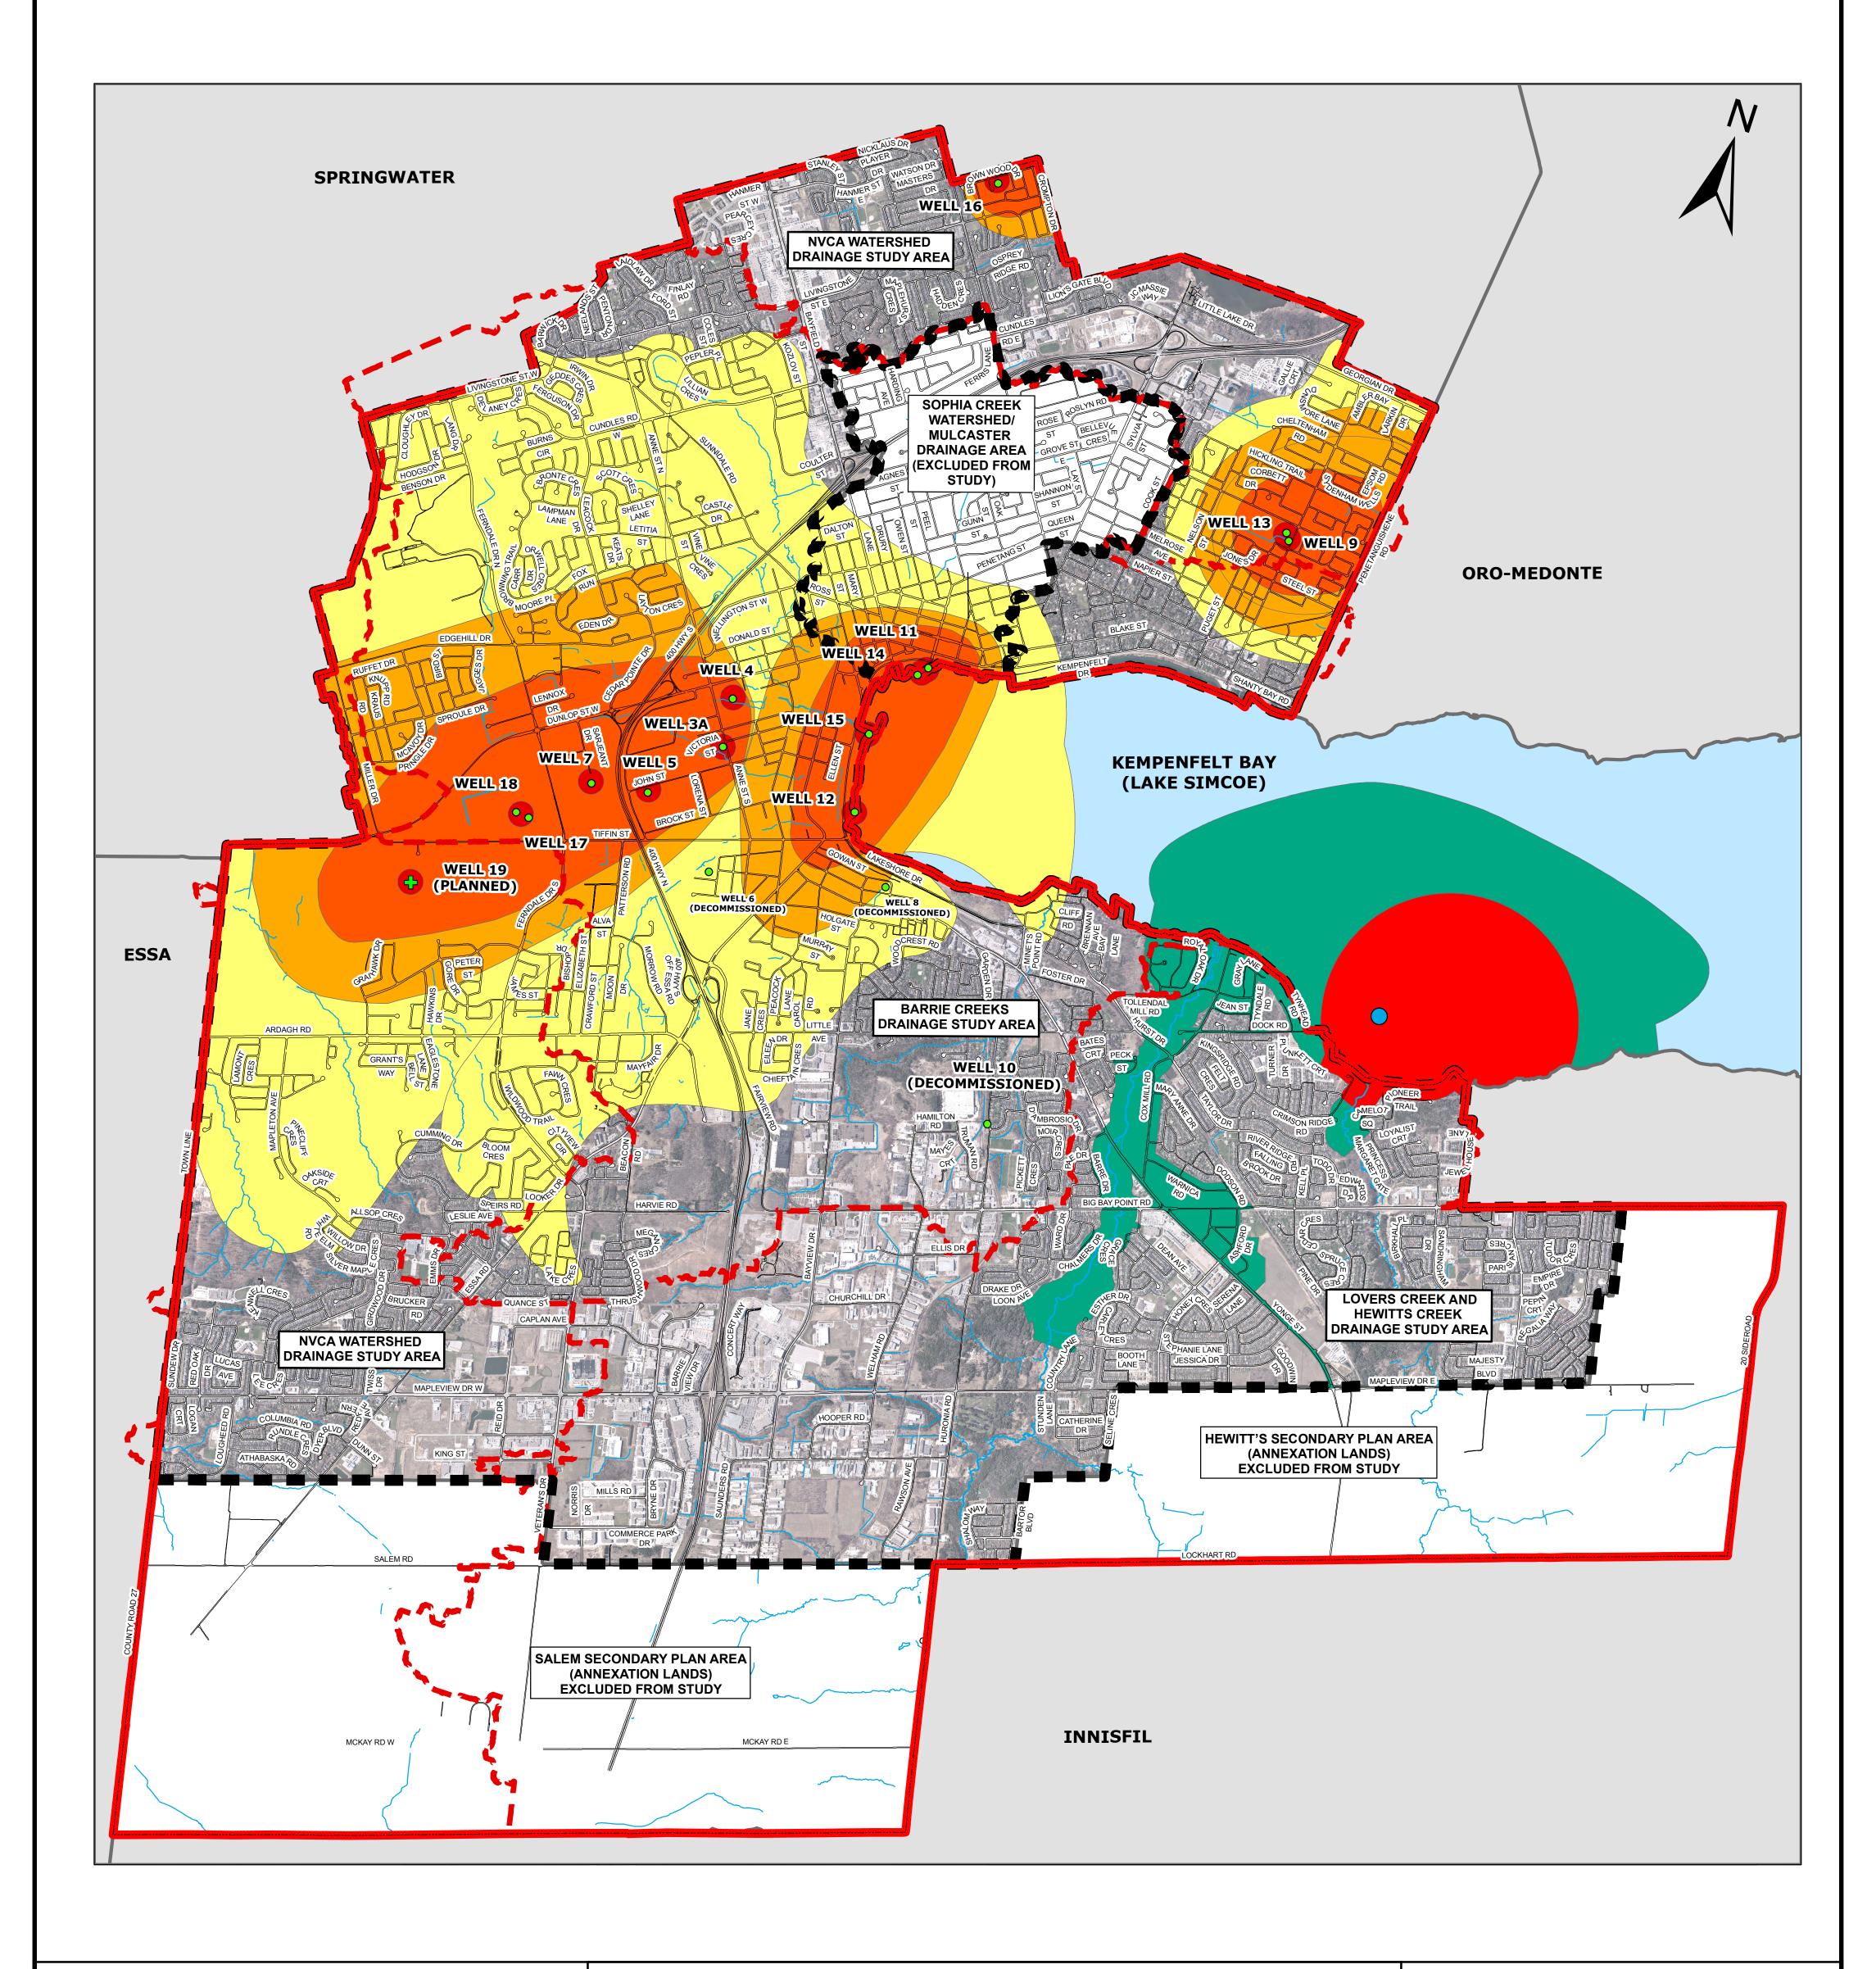FIGURE 9 - SWMF RETROFIT/CREATION OPPORTUNITIES (TO BE EVALUATED)



Source: Approved Assessment Report:
Lake Simcoe and CouchichingBlack River Source Protection
Area Part 1. South Georgian
Bay – Lake Simcoe Source
Protection Committee (2011)

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ROADS WATERCOURSES DRAINAGE STUDY AREA BOUNDARY ■ OVERALL STUDY AREA ANNEXATION LANDS (EXCLUDED FROM STUDY) SOPHIA CREEK AND MULCASTER DRAINAGE AREAS (EXCLUDED FROM STUDY) MUNICIPAL BOARDER INTAKE PROTECTION ZONE 1 (VULNERABILITY SCORE 8) INTAKE PROTECTION ZONE 2 (VULNERABILITY SCORE 6.4) **WHPA** WHPA-A (100m RADIUS) WHPA-B (2yr TIME OF TRAVEL) WHPA-C (10yr TIME OF TRAVEL) WHPA-D (25yr TIME OF TRAVEL) SURFACE WATER INTAKE (TYPE D)


Legend

BCIFIC

SCALE = 1:24,000

DRAINAGE MASTER PLAN

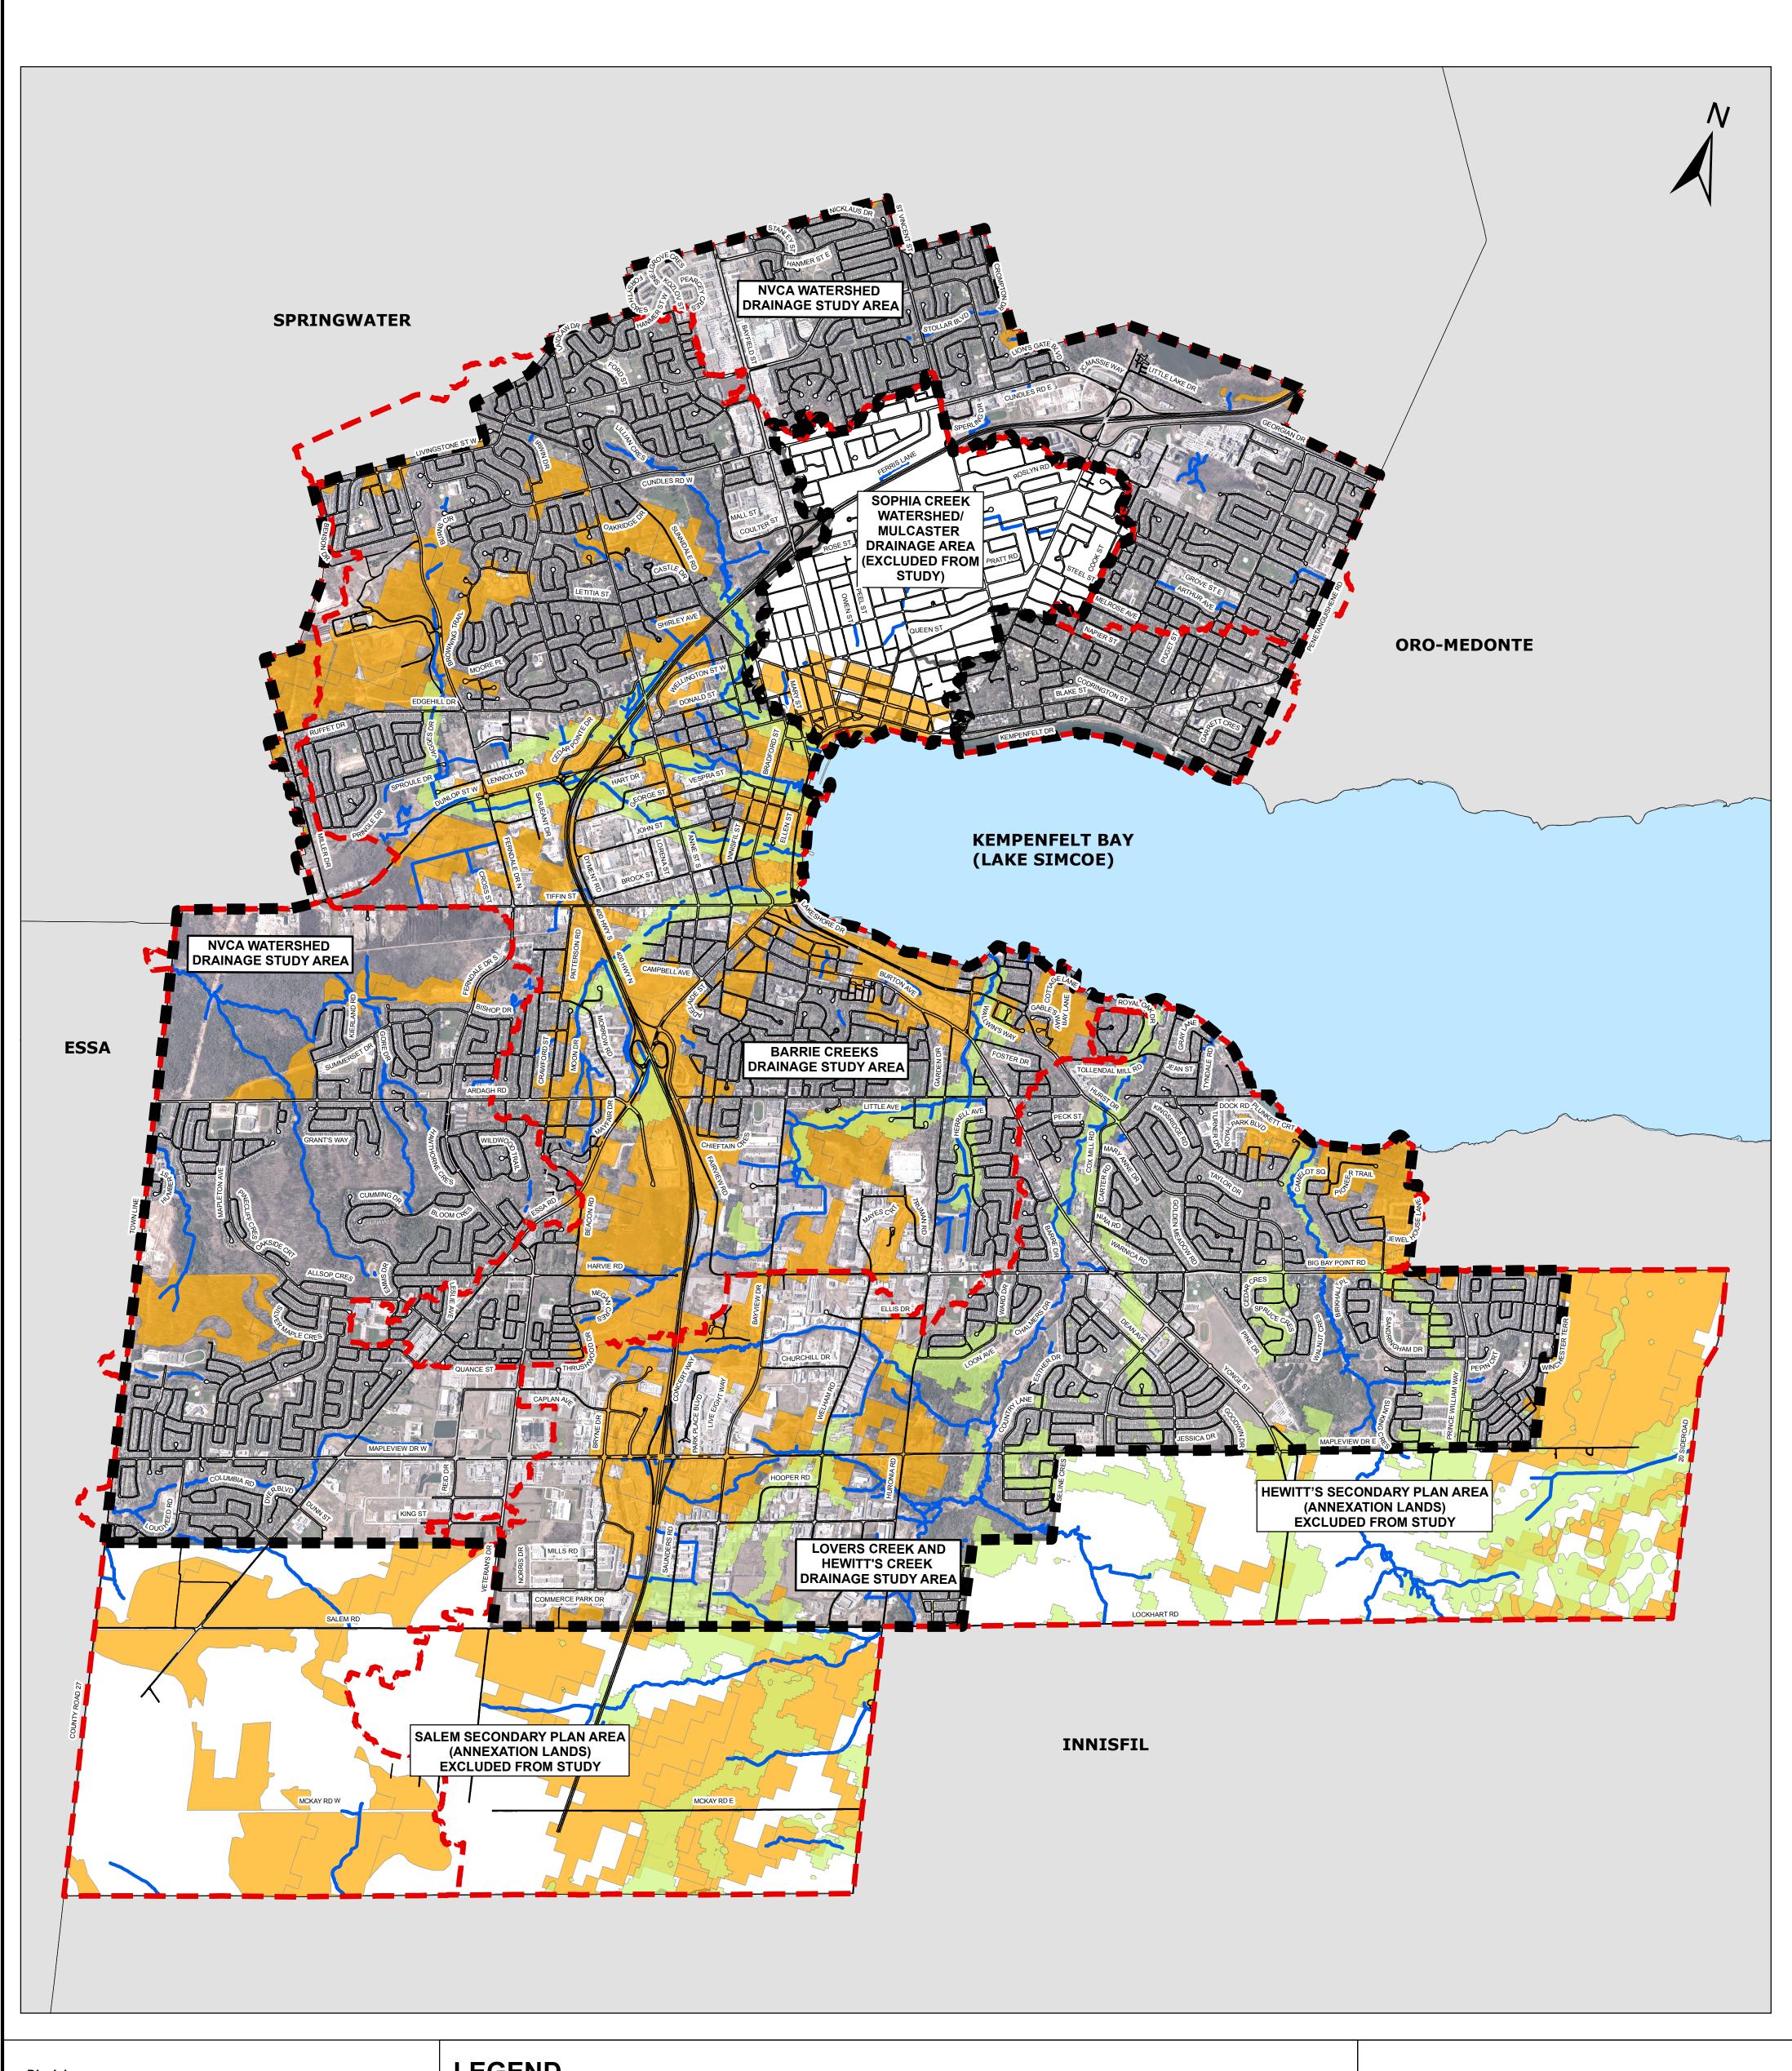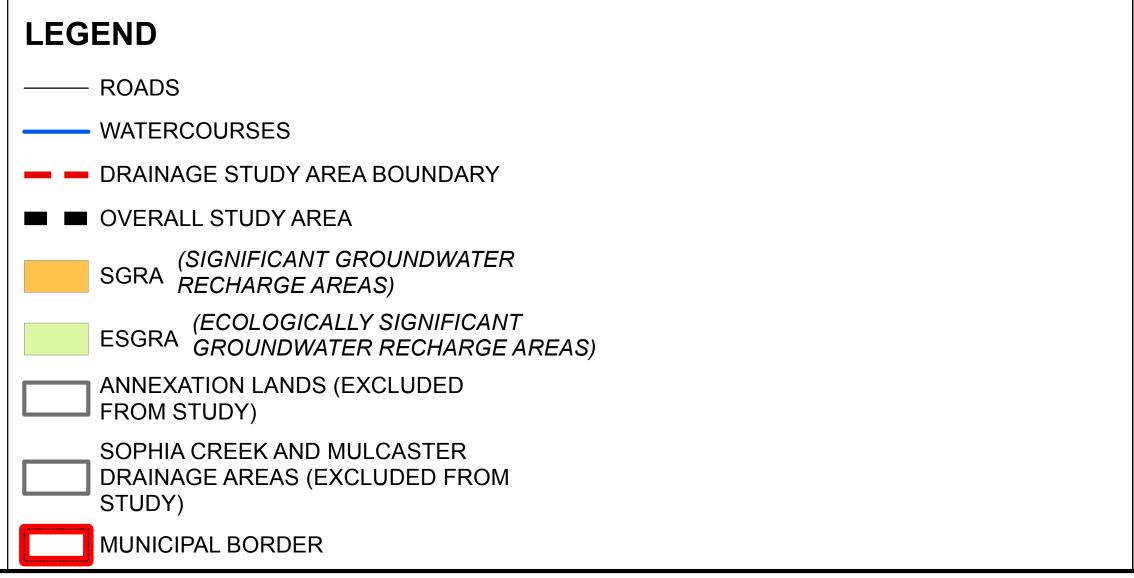
FIGURE 10 - KNOWN WELLHEAD PROTECTION AREA/INTAKE PROTECTION AREA PLAN

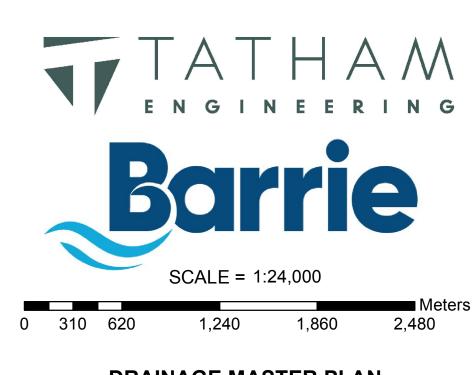


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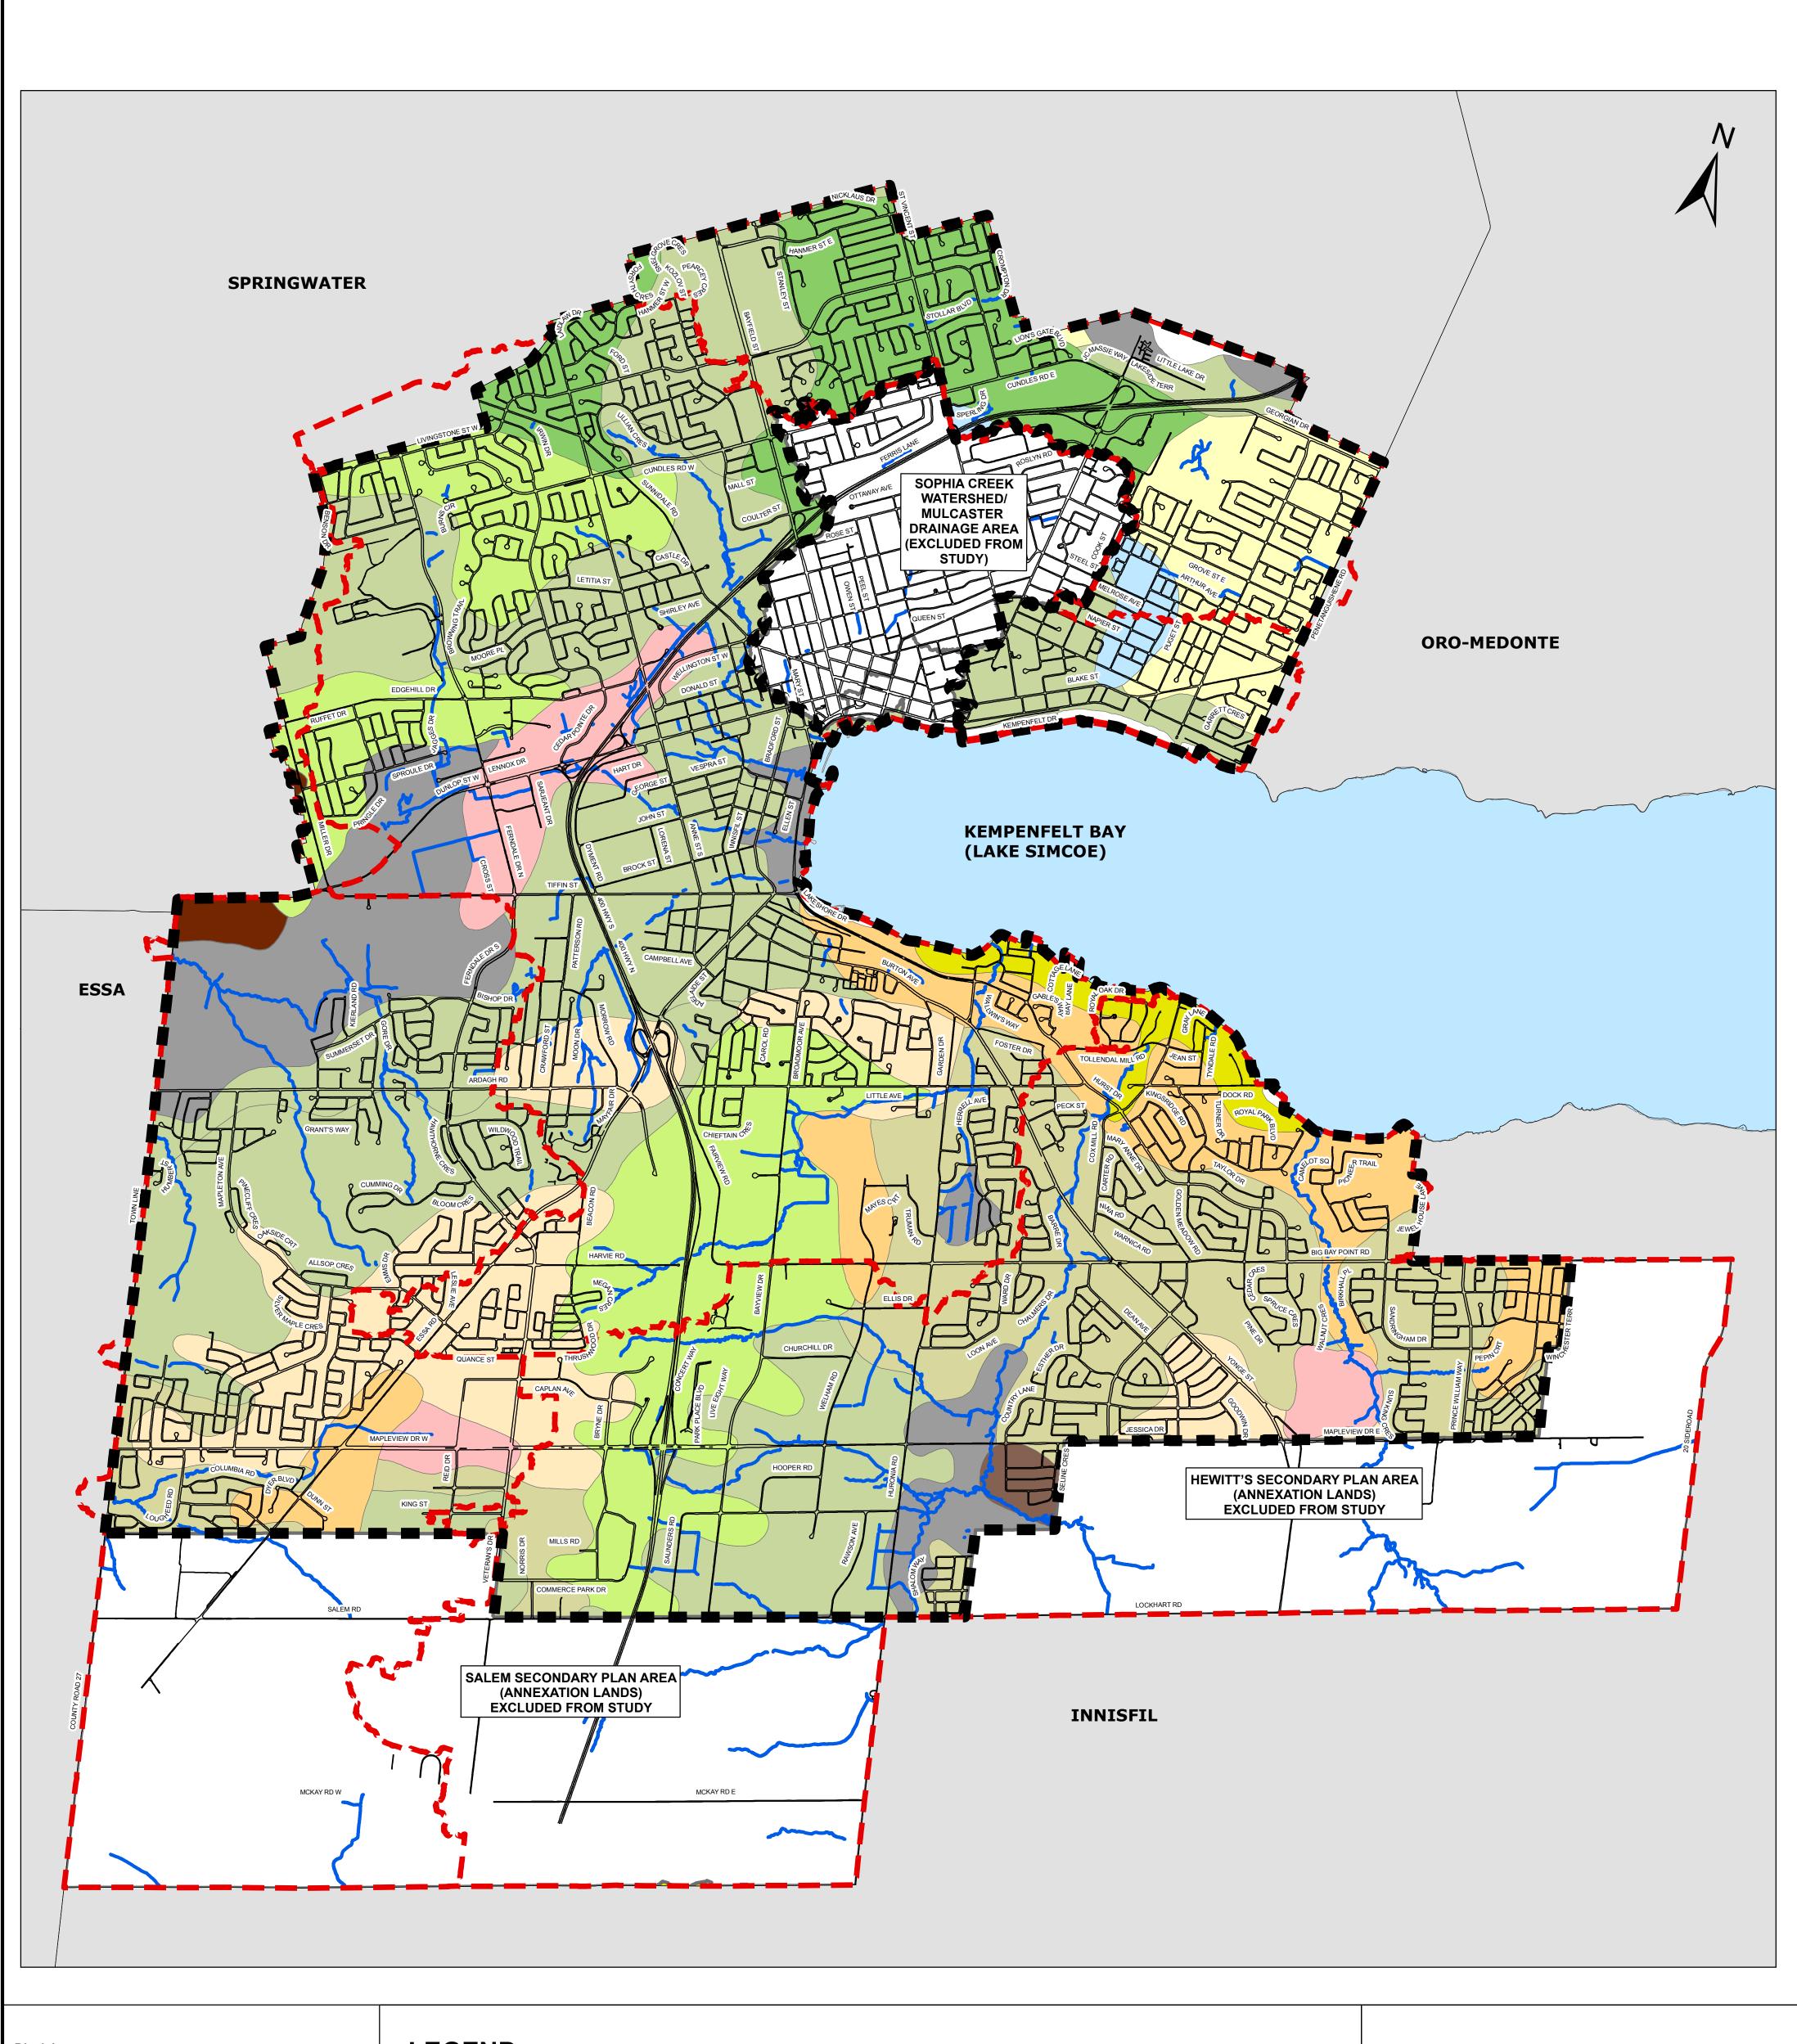
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DRAINAGE MASTER PLAN

FIGURE 11 - GROUNDWATER RECHARGE AREA PLAN




Disclaimer


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This drawing.

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LEGEND ----- ROADS Bs-b - BONDHEAD SANDY LOAM - STONY PHASE (AB) **WATERCOURSES** Bs-b - BONDHEAD SANDY LOAM - STONY — DRAINAGE STUDY AREA BOUNDARY PHASE (AB) ■ OVERALL STUDY AREA GsI - GRANBY SANDY LOAM ANNEXATION LANDS Gul - GUERIN LOAM (B) (EXCLUDED FROM STUDY) M - MUCK (B) SOPHIA CREEK WATERSHED AND Shsc - SCHOMBERG SILTY CLAY LOAM (C) MULCASTER DRAINAGE AREA (EXCLUDED FROM STUDY) Smsc - SMITHFIELD SILTY CLAY LAOM MUNICIPAL BORDER Stsl - SARGENT GRAVELLY SANDY LOAM (A) HYDROLOGIC SOIL GROUPS Tis - TIOGA LOAMY SAND (A) Ans - ALLISTON SANDY LOAM (AB) Tis-b BI - BONDHEAD LOAM (B) Tisl - TIOGA SANDY LOAM (A) Bs - BONDHEAD SANDY LOAM (AB) Vasl - VASEY SANDY LOAM (AB)



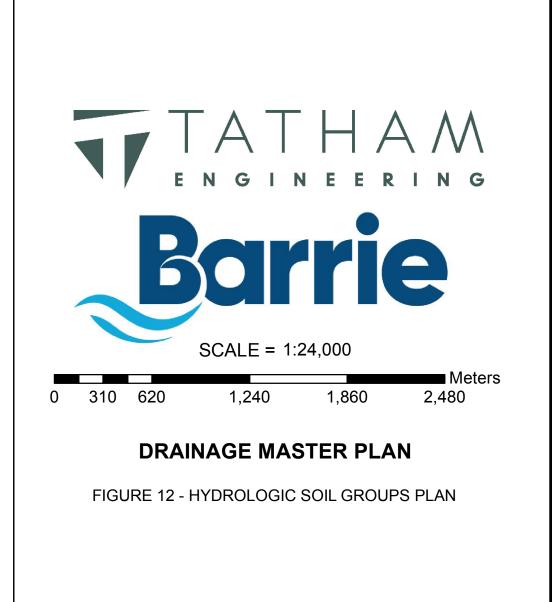
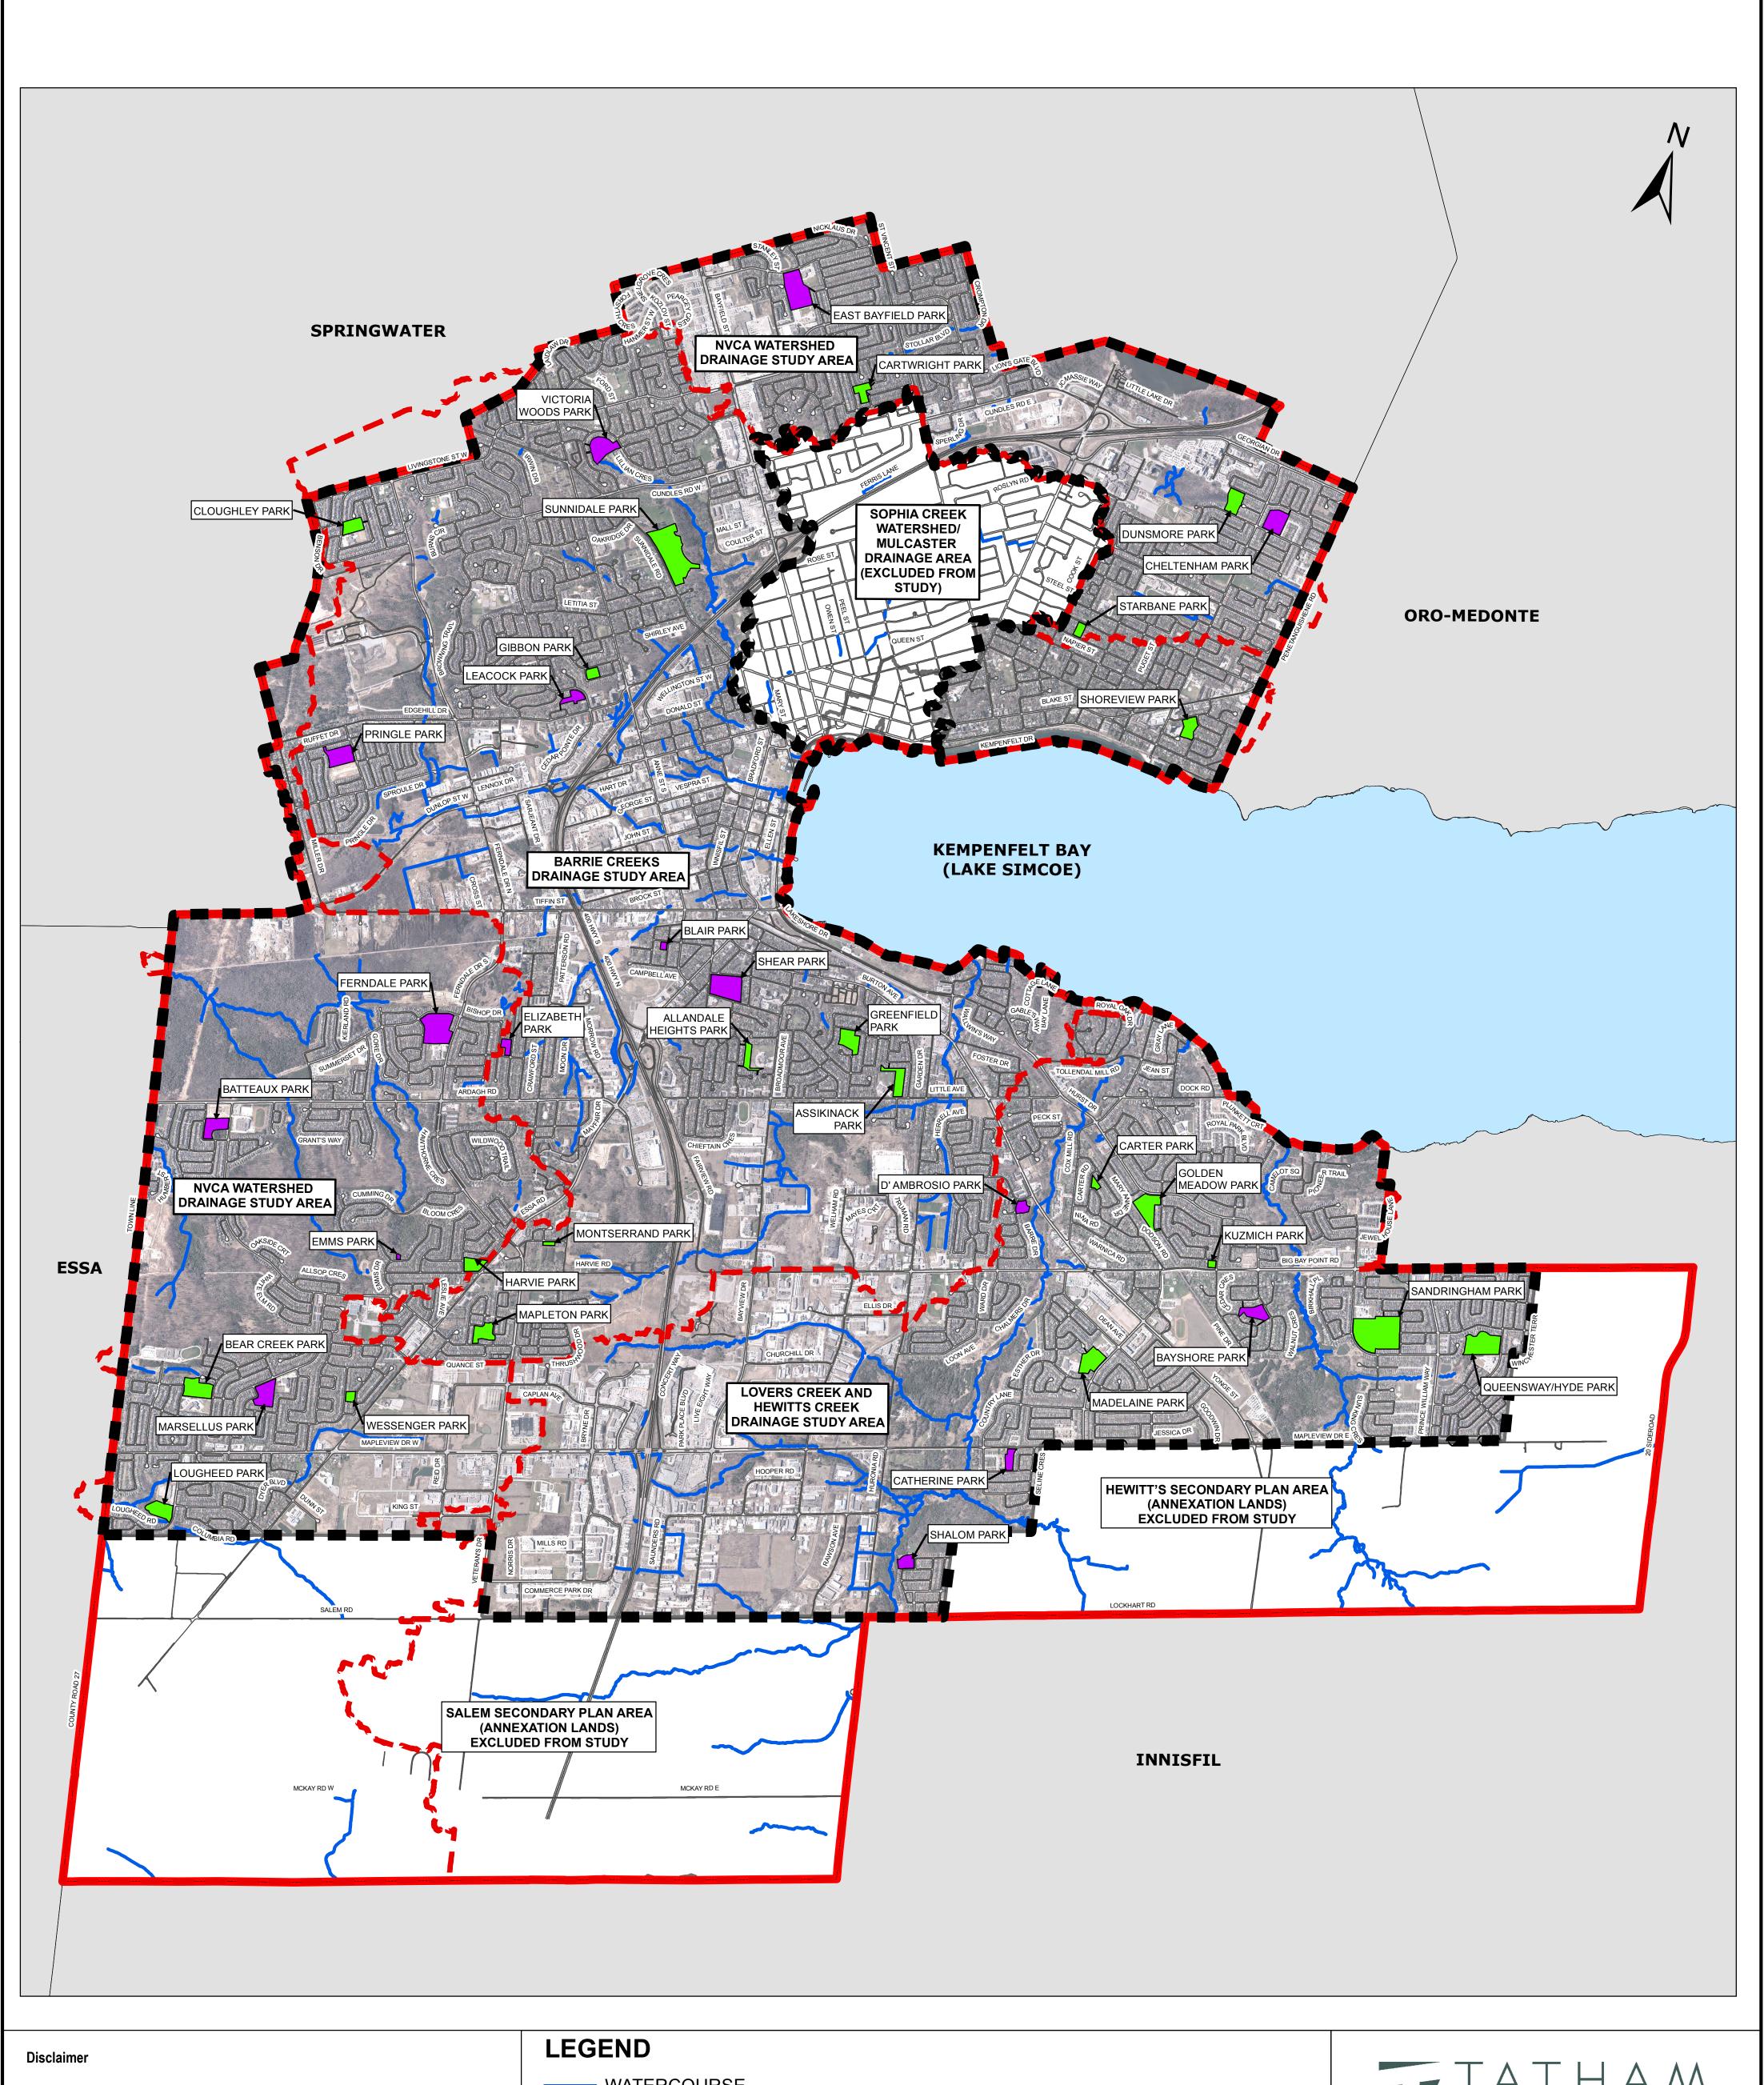
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LEGEND WATERCOURSE ROADS DRAINAGE STUDY AREA BOUNDARY OVERALL STUDY AREA PARKLAND CONSIDERED FOR CENTRALIZED LID AND RECOMMENDED FOR FURTHER CONSIDERATION PARKLAND CONSIDERED FOR CENTRALIZED LID AND ELIMINATED FOR FURTHER CONSIDERATION ANNEXATION LANDS (EXCLUDED FROM STUDY) SOPHIA CREEK WATERSHED AND MULCASTER DRAINAGE AREA (EXCLUDED FROM STUDY) MUNICIPAL BORDER



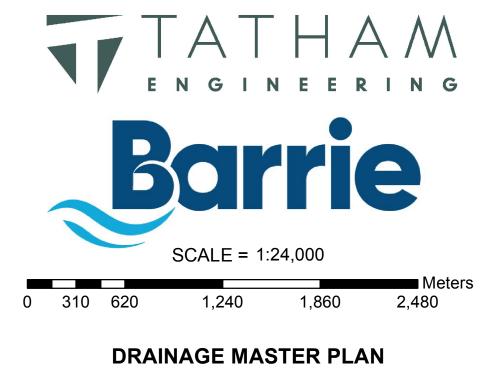


FIGURE 13 - CENTRALIZED LID OPPORTUNITIES (PRE-SCREENING EVALUATION)

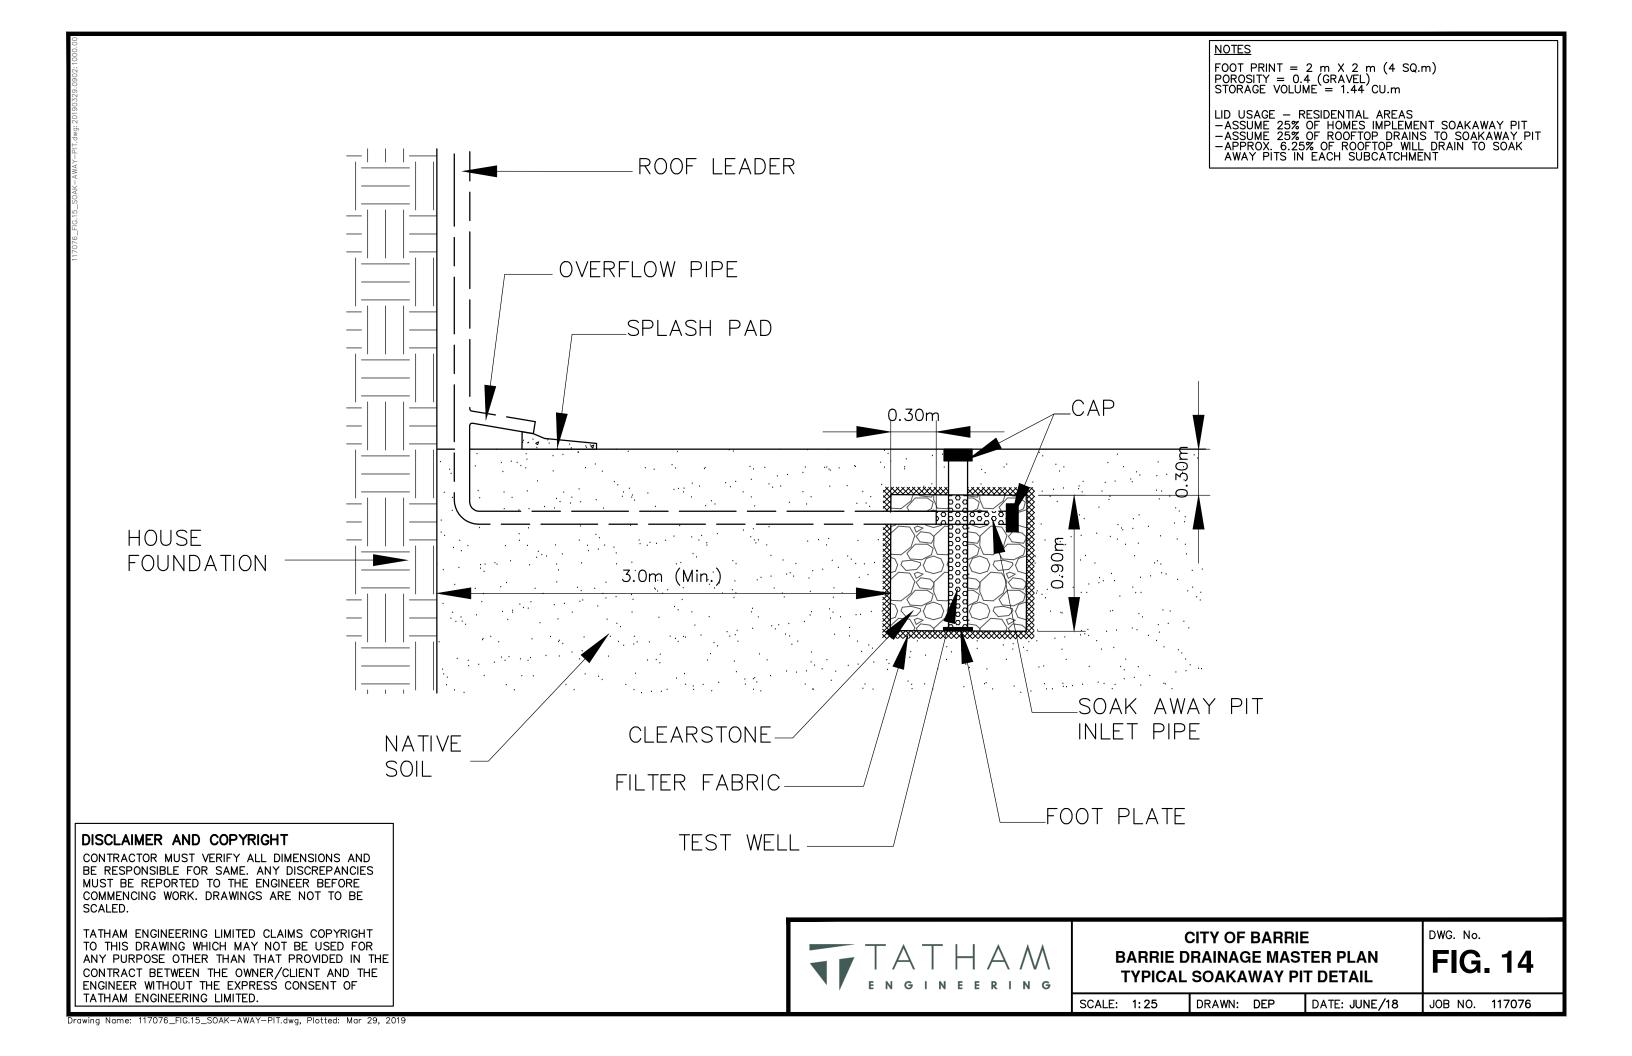

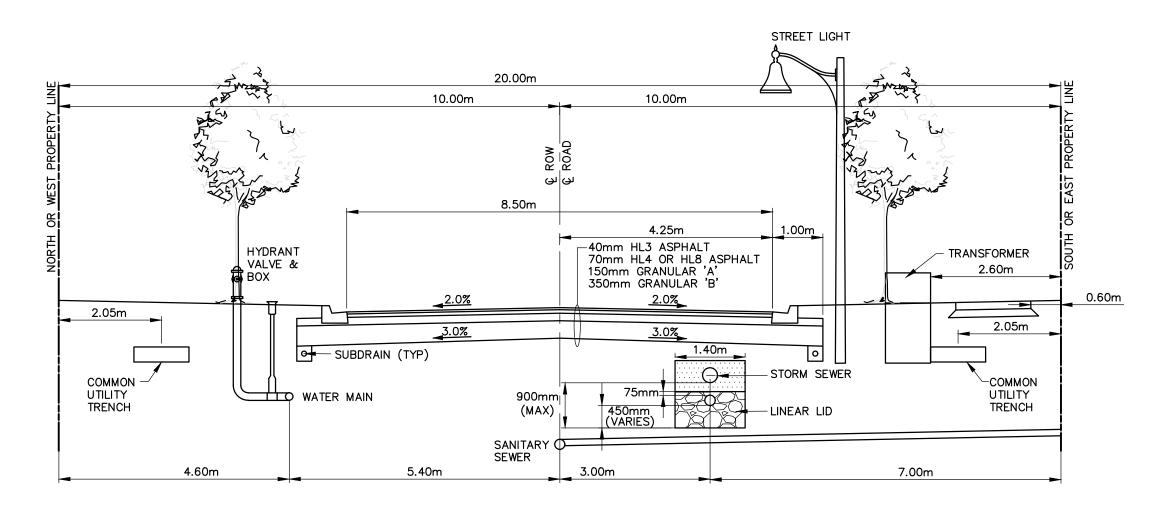

20m ROW - URBAN CROSS-SECTION WITH LINEAR LID

NTS

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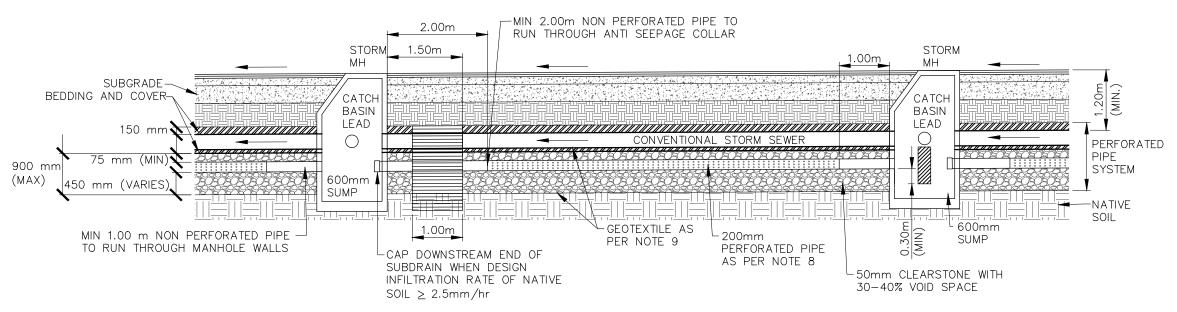
CITY OF BARRIE BARRIE DRAINAGE MASTER PLAN TYPICAL LINEAR LID ROAD CROSS-SECTION

FIG. 15A

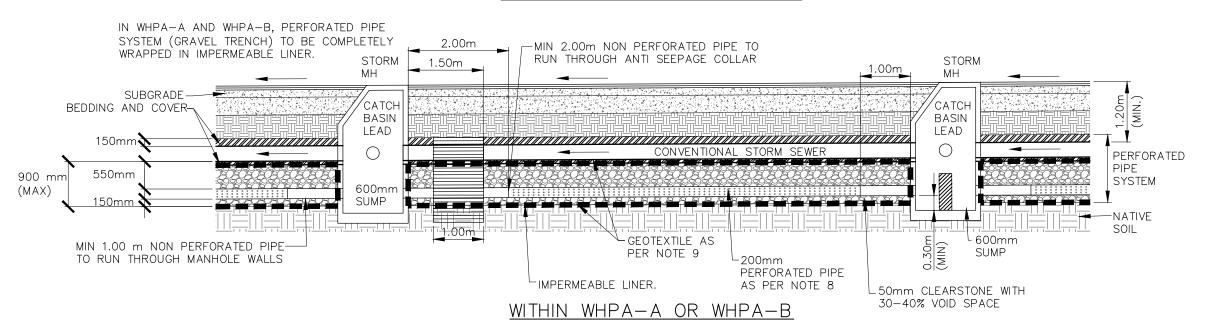
SCALE: 1:75

DRAWN: DEP

DATE: JUNE/17



OUTSIDE WHPA-A OR WHPA-B



NOTES

- 1. STORMWATER CONVENTIONAL SYSTEM TO BE DESIGNED IN ACCORDANCE WITH THE CITY OF BARRIE STORM
- 2. PERFORATED PIPES TO BE PLUGGED AT DOWNSTREAM END USING APPROPRIATE SIZED MECHANICAL PLUG OR EQUIVALENT. TEMP. PLUG TO BE INSTALLED UNTIL TRIBUTARY AREA IS STABLIZED.
- GRAVEL BED AND INLET PIPE TO BE BELOW LOCAL FROST LINE AND BE INSTALLED IN RECTANGULAR EXCAVATIONS WITH A BOTTOM WIDTH MIN. 1.4m.
- 4. BAFFLE SHALL BE INSTALLED IN UPSTREAM MANHOLE PER MANUFACTURERS INSTRUCTIONS.
- ANTI-SEEPAGE COLLARS SHALL BE INSTALLED ON ALL PERFORATED PIPES OR AS DIRECTED BY A GEOTECHNICAL ENGINEER.
- FLOWS SHALL BE COLLECTED BY USE OF CONVENTIONAL CATCHBASINS COMPLETE WITH MINIMUM PRETREATMENT THE CITY OF BARRIE STORM DRAINAGE MANUAL.
- 7. BEARING CAPACITY OF INFILTRATION SOIL SHALL BE ASSESSED, AND INFILTRATION TRENCH DESIGNED SUCH THAT SETTLEMENT OF THE UNDERLYING SOILS DOES NOT NEGATIVELY AFFECT INFILTRATION RATES, OR RESULT IN SETTLEMENT & REDUCED LIFESPAN OF THE ROAD STRUCTURE ABOVE.
- 8. ALL PERFORATED PIPES TO BE SMOOTH WALLED MIN 200mm INSIDE DIA. CONTINUOUSLY PERFORATED TYPE SDR28 PVC PIPE, WITH 4X12 PERFORATIONS TO A MAXIMUM SPACING OF 150mm, WRAPPED WITH GEOTEXTILE SOCK PER OPSS 1860, CLASS II, NON-WOVEN NEEDLE PUNCHED OR WOVEN MONOFILAMENT AND COVERED WITH MIN. 75mm CLEAR STONE OVER PIPE.
- 9. GEOTEXTILE FABRIC PER OPSS 1860, CLASS II, NON-WOVEN NEEDLE PUNCHED OR WOVEN MONOFILAMENT TO BE INSTALLED AROUND ALL TRENCH FACILITIES WITH 300mm MIN. OVERLAP.
- 10. CATCHBASINS PER OPSD 705.010, TO HAVE 900mm SUMP AND MINIMUM PRETREATMENT, AS DEFINED IN THE CITY OF BARRIE DRAINAGE MANUAL.

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CITY OF BARRIE BARRIE DRAINAGE MASTER PLAN TYPICAL LINEAR LID DETAIL


DWG. No.

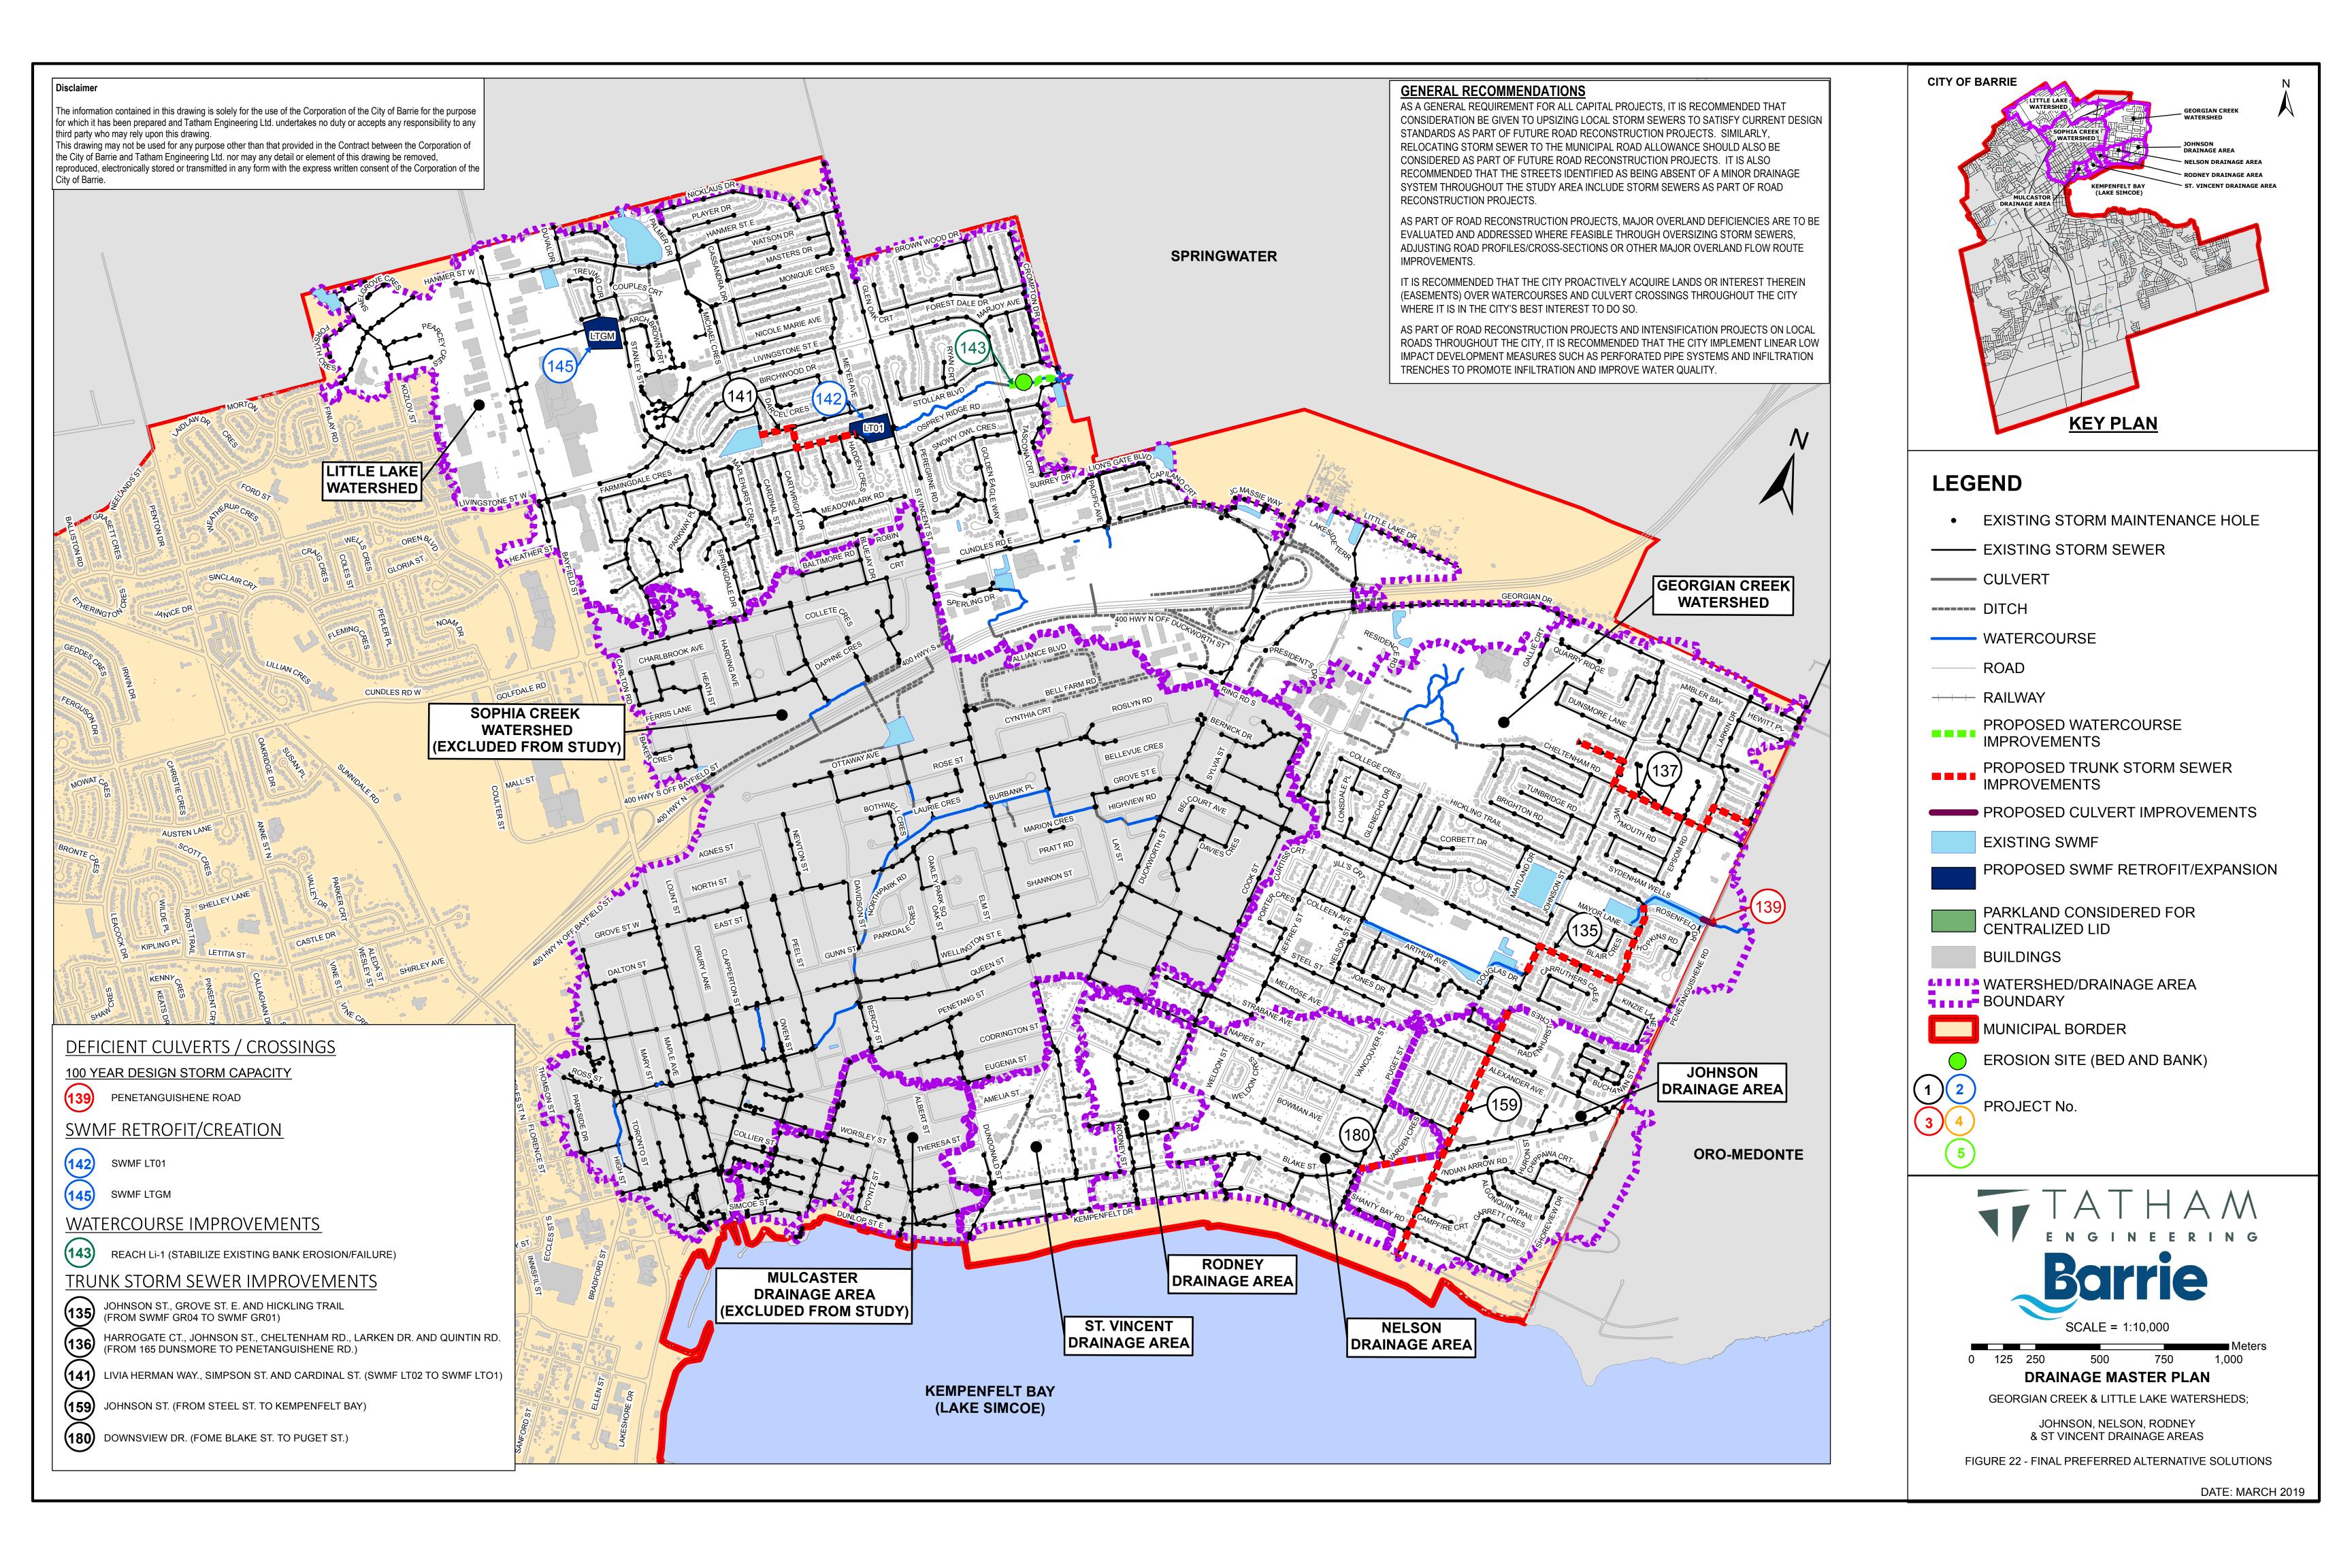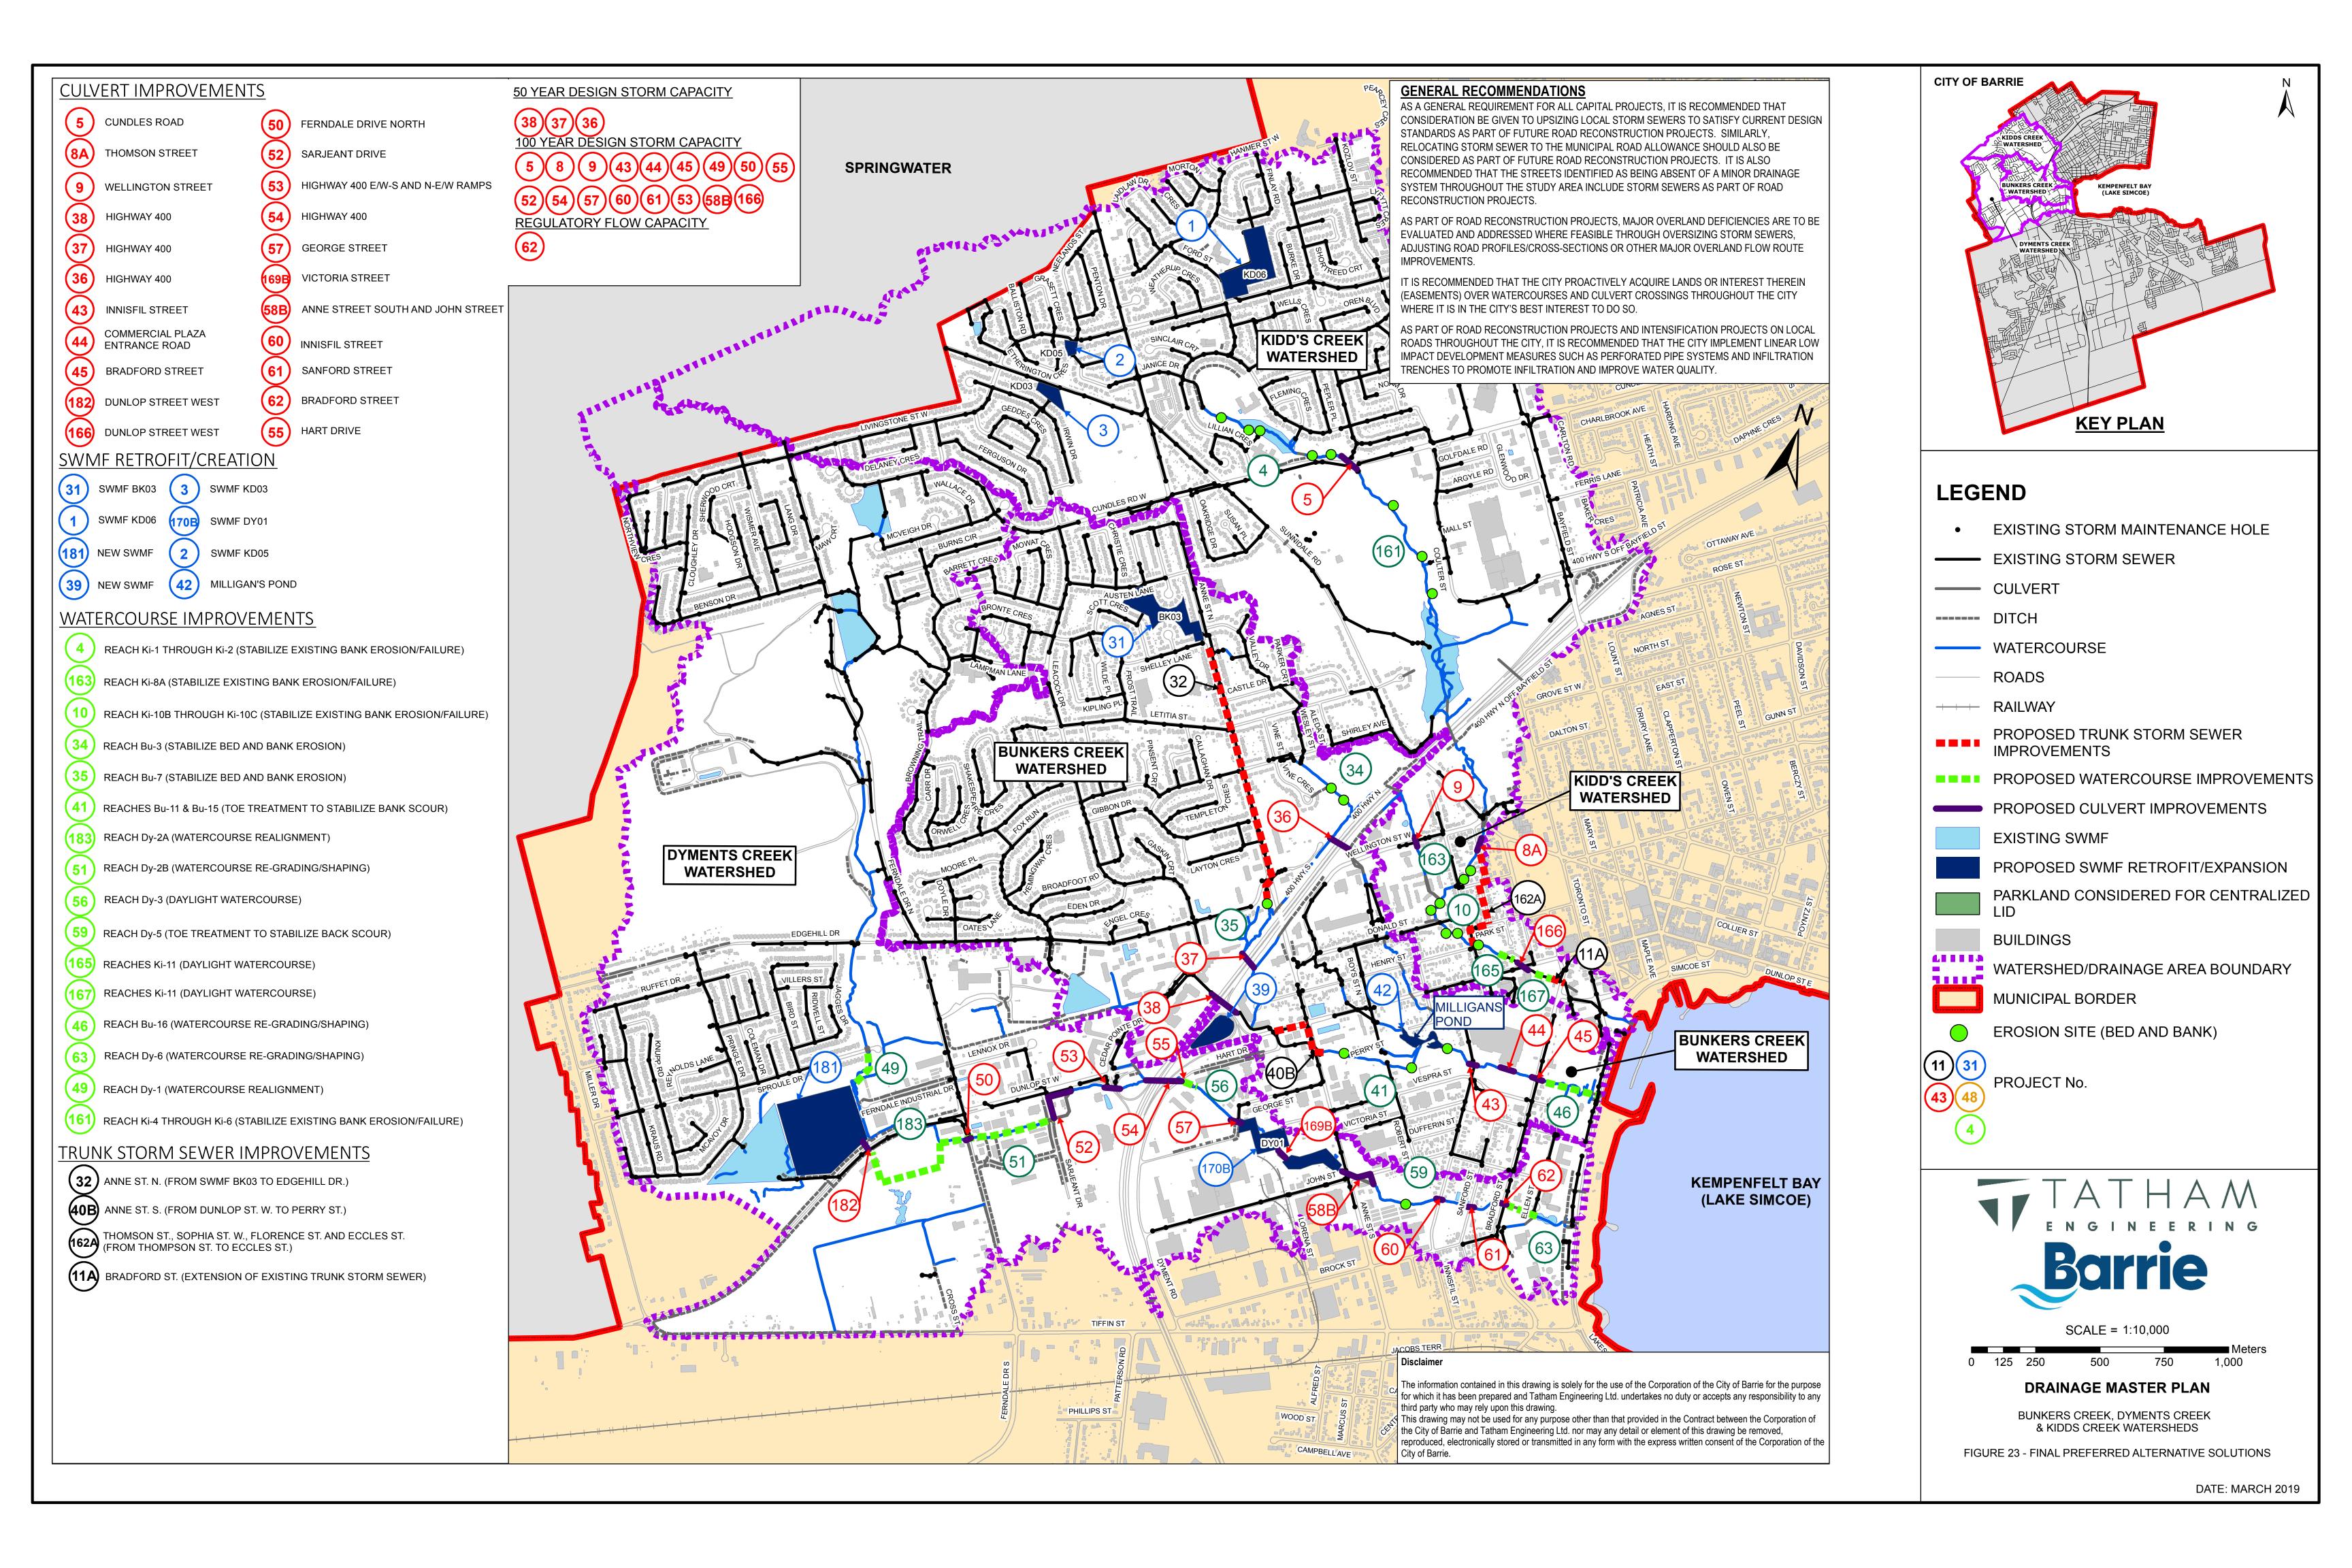
FIG. 15B

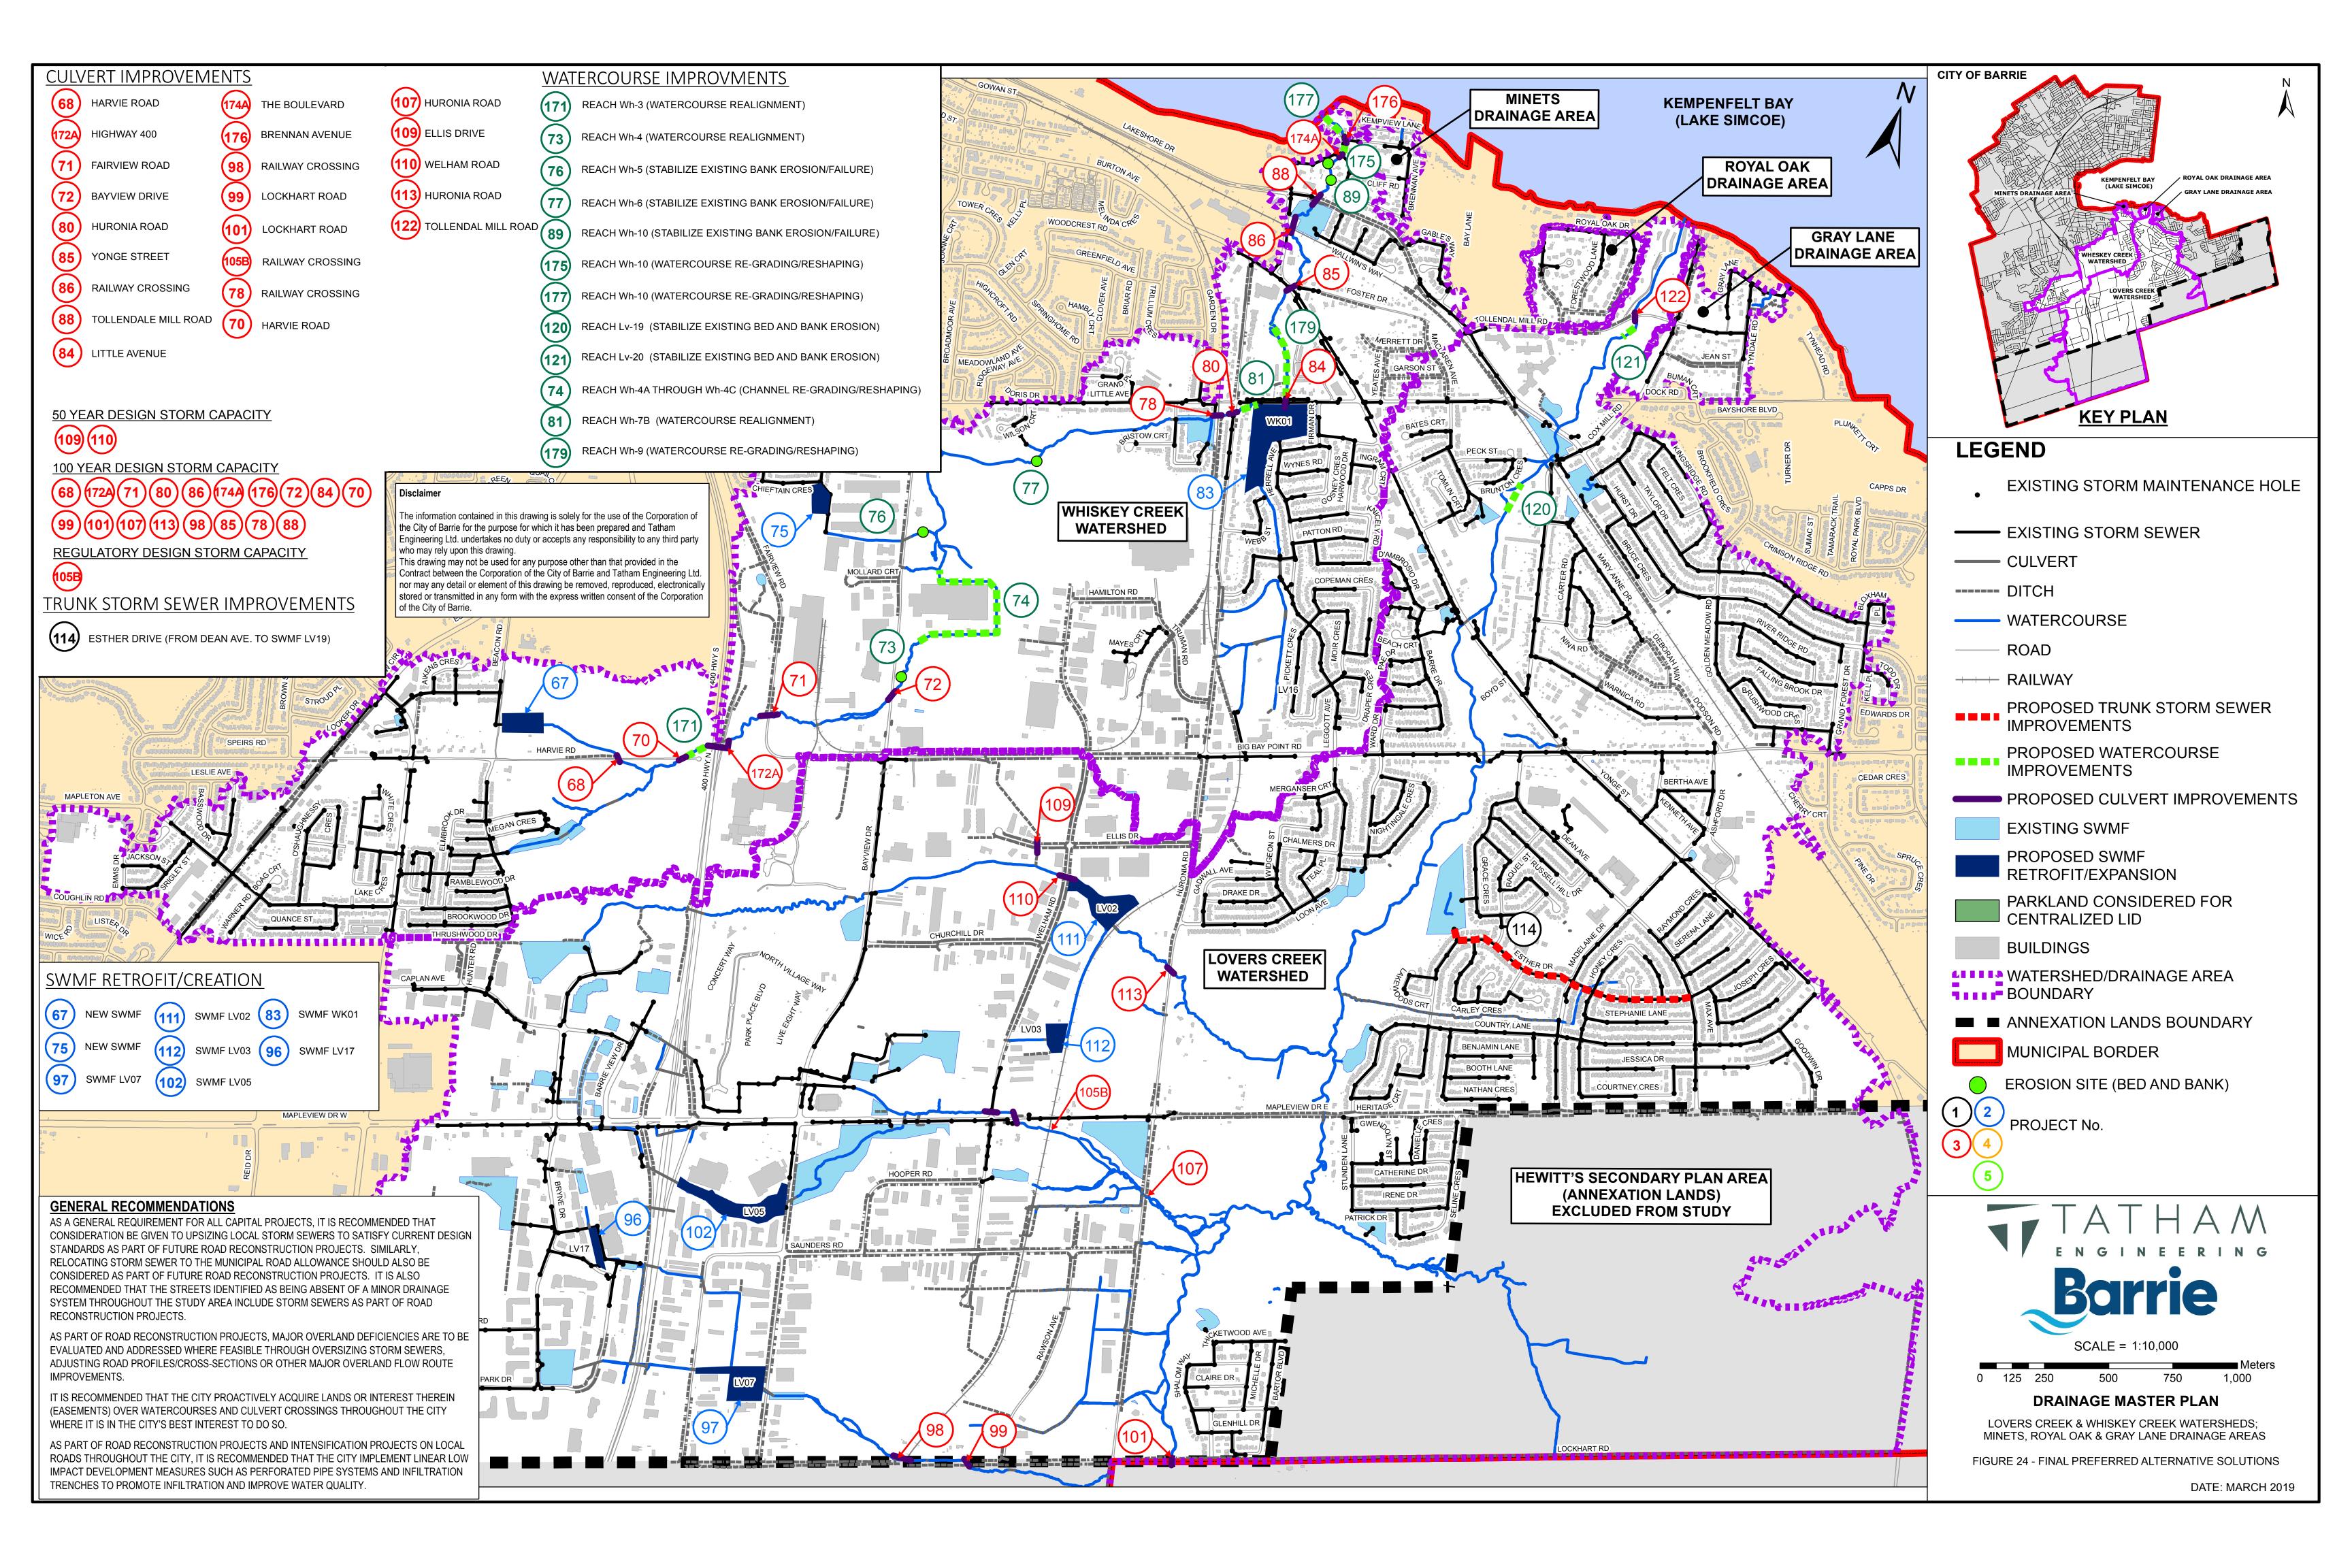
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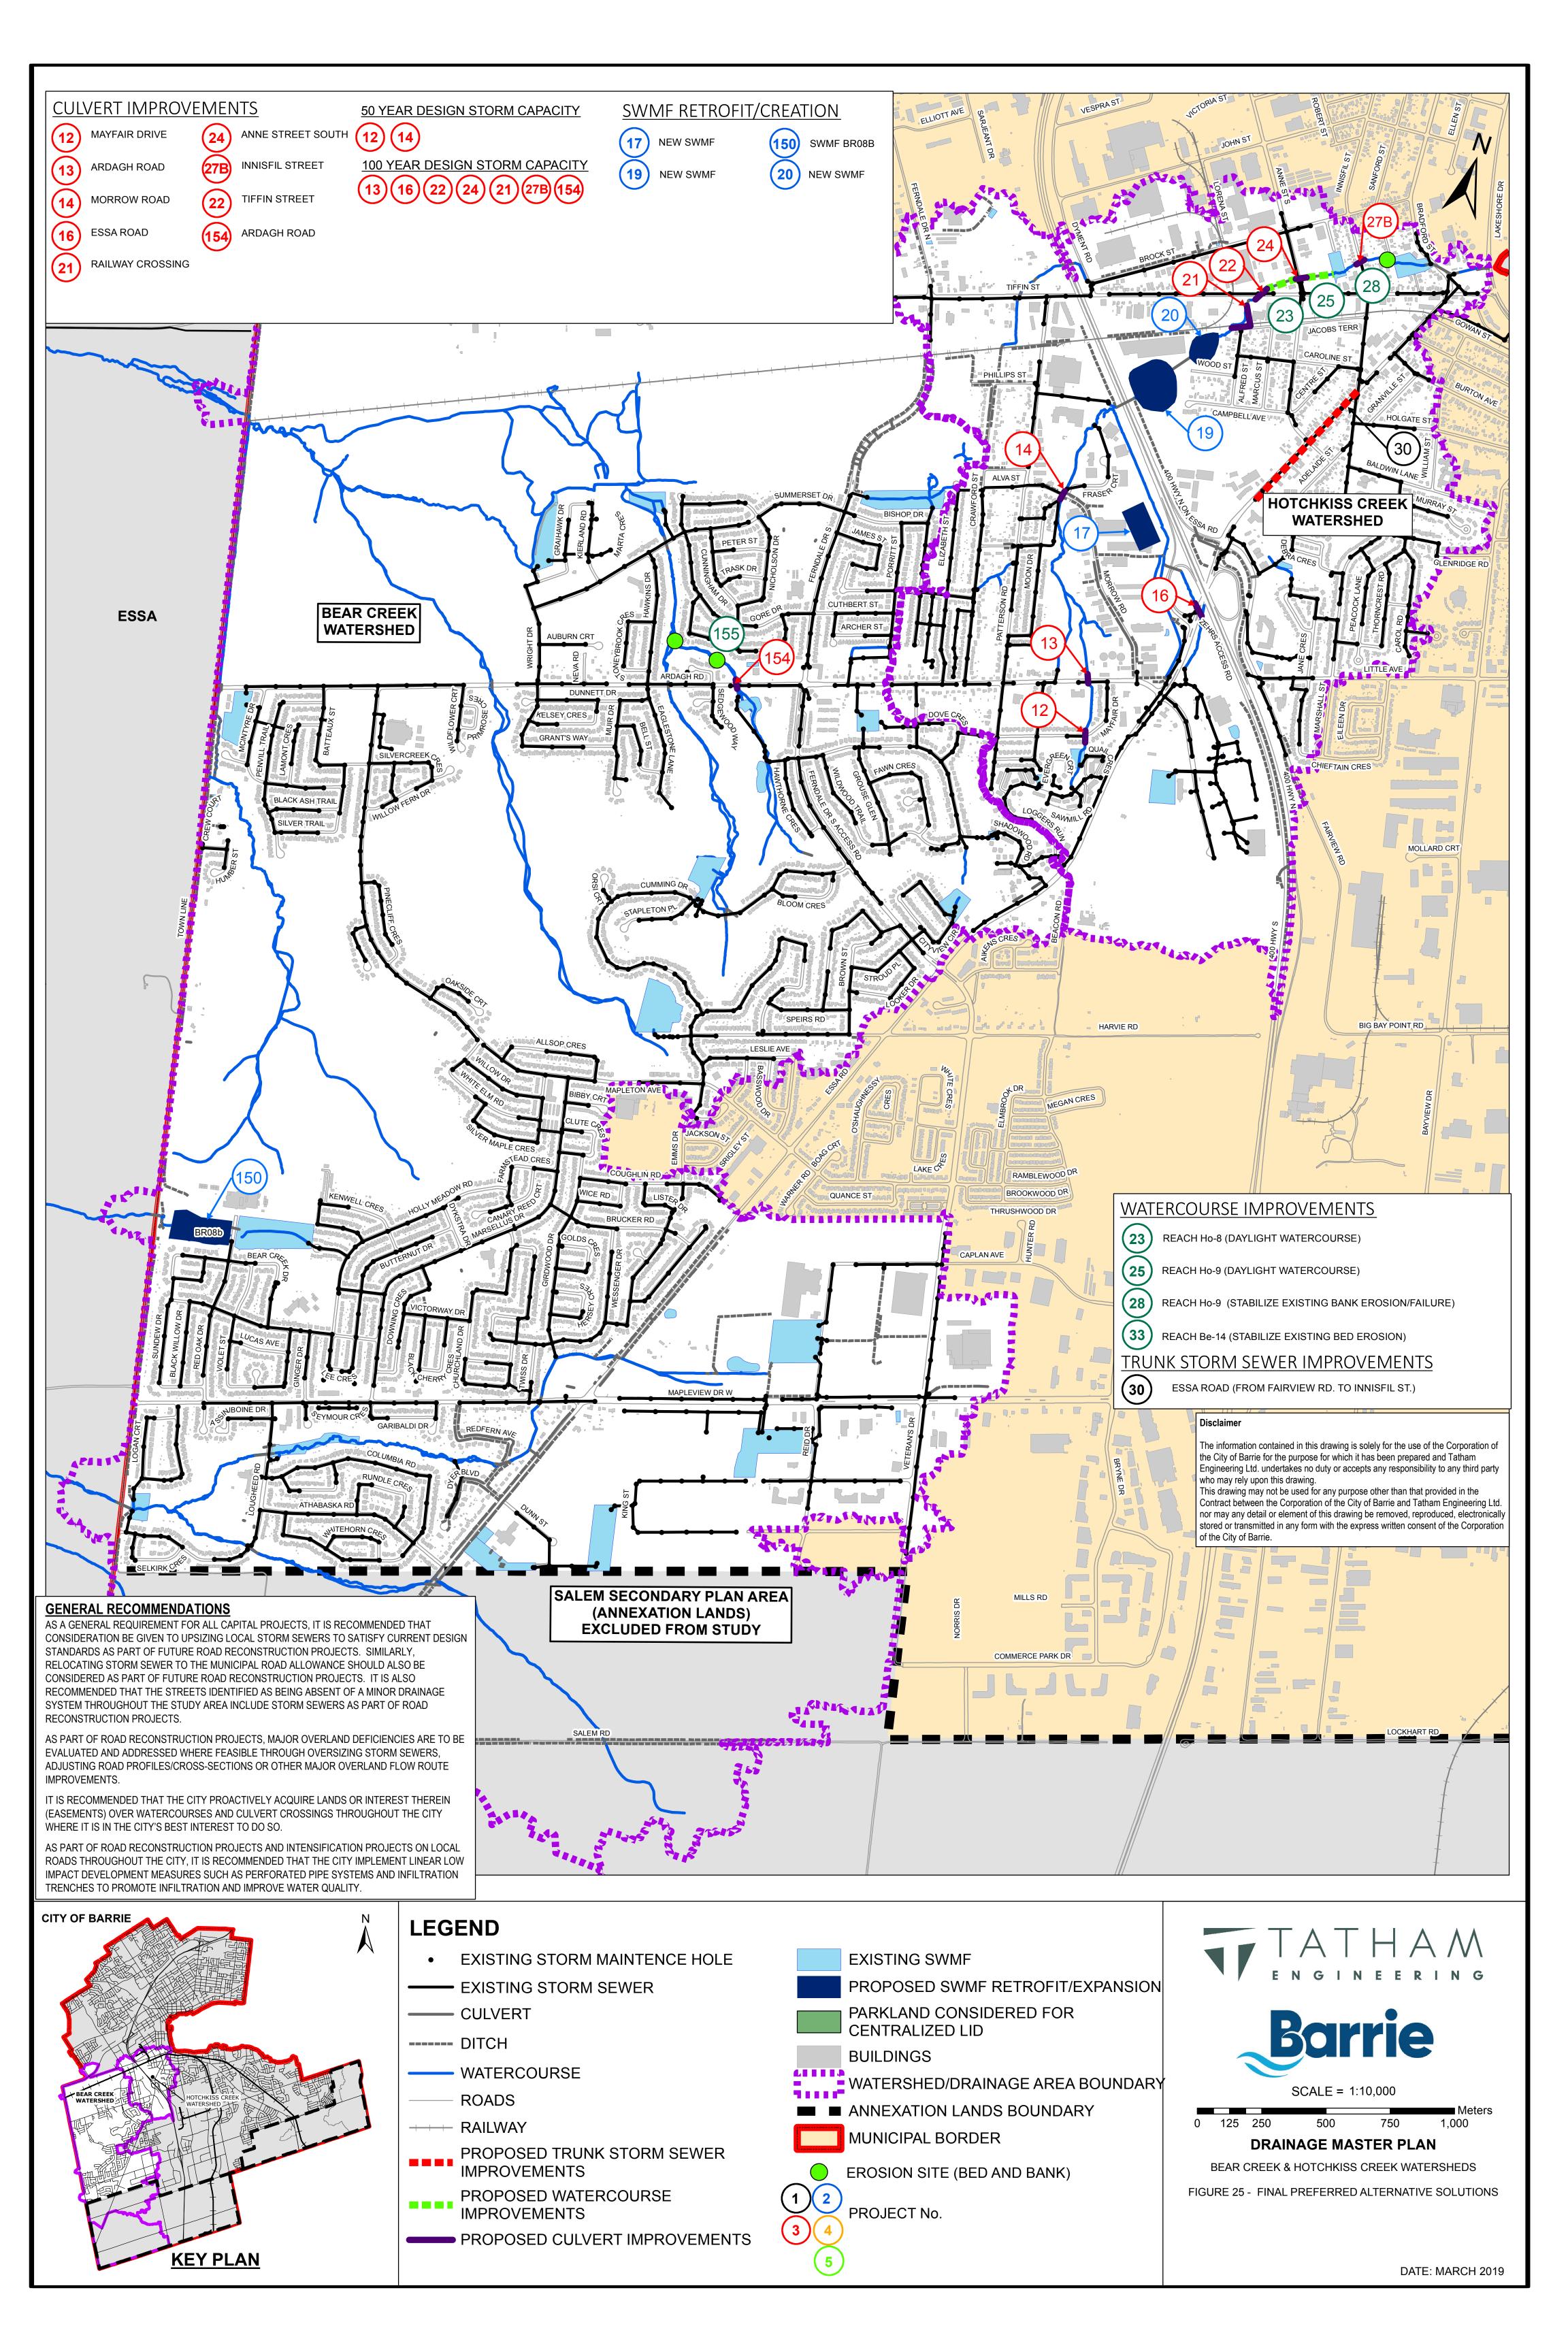
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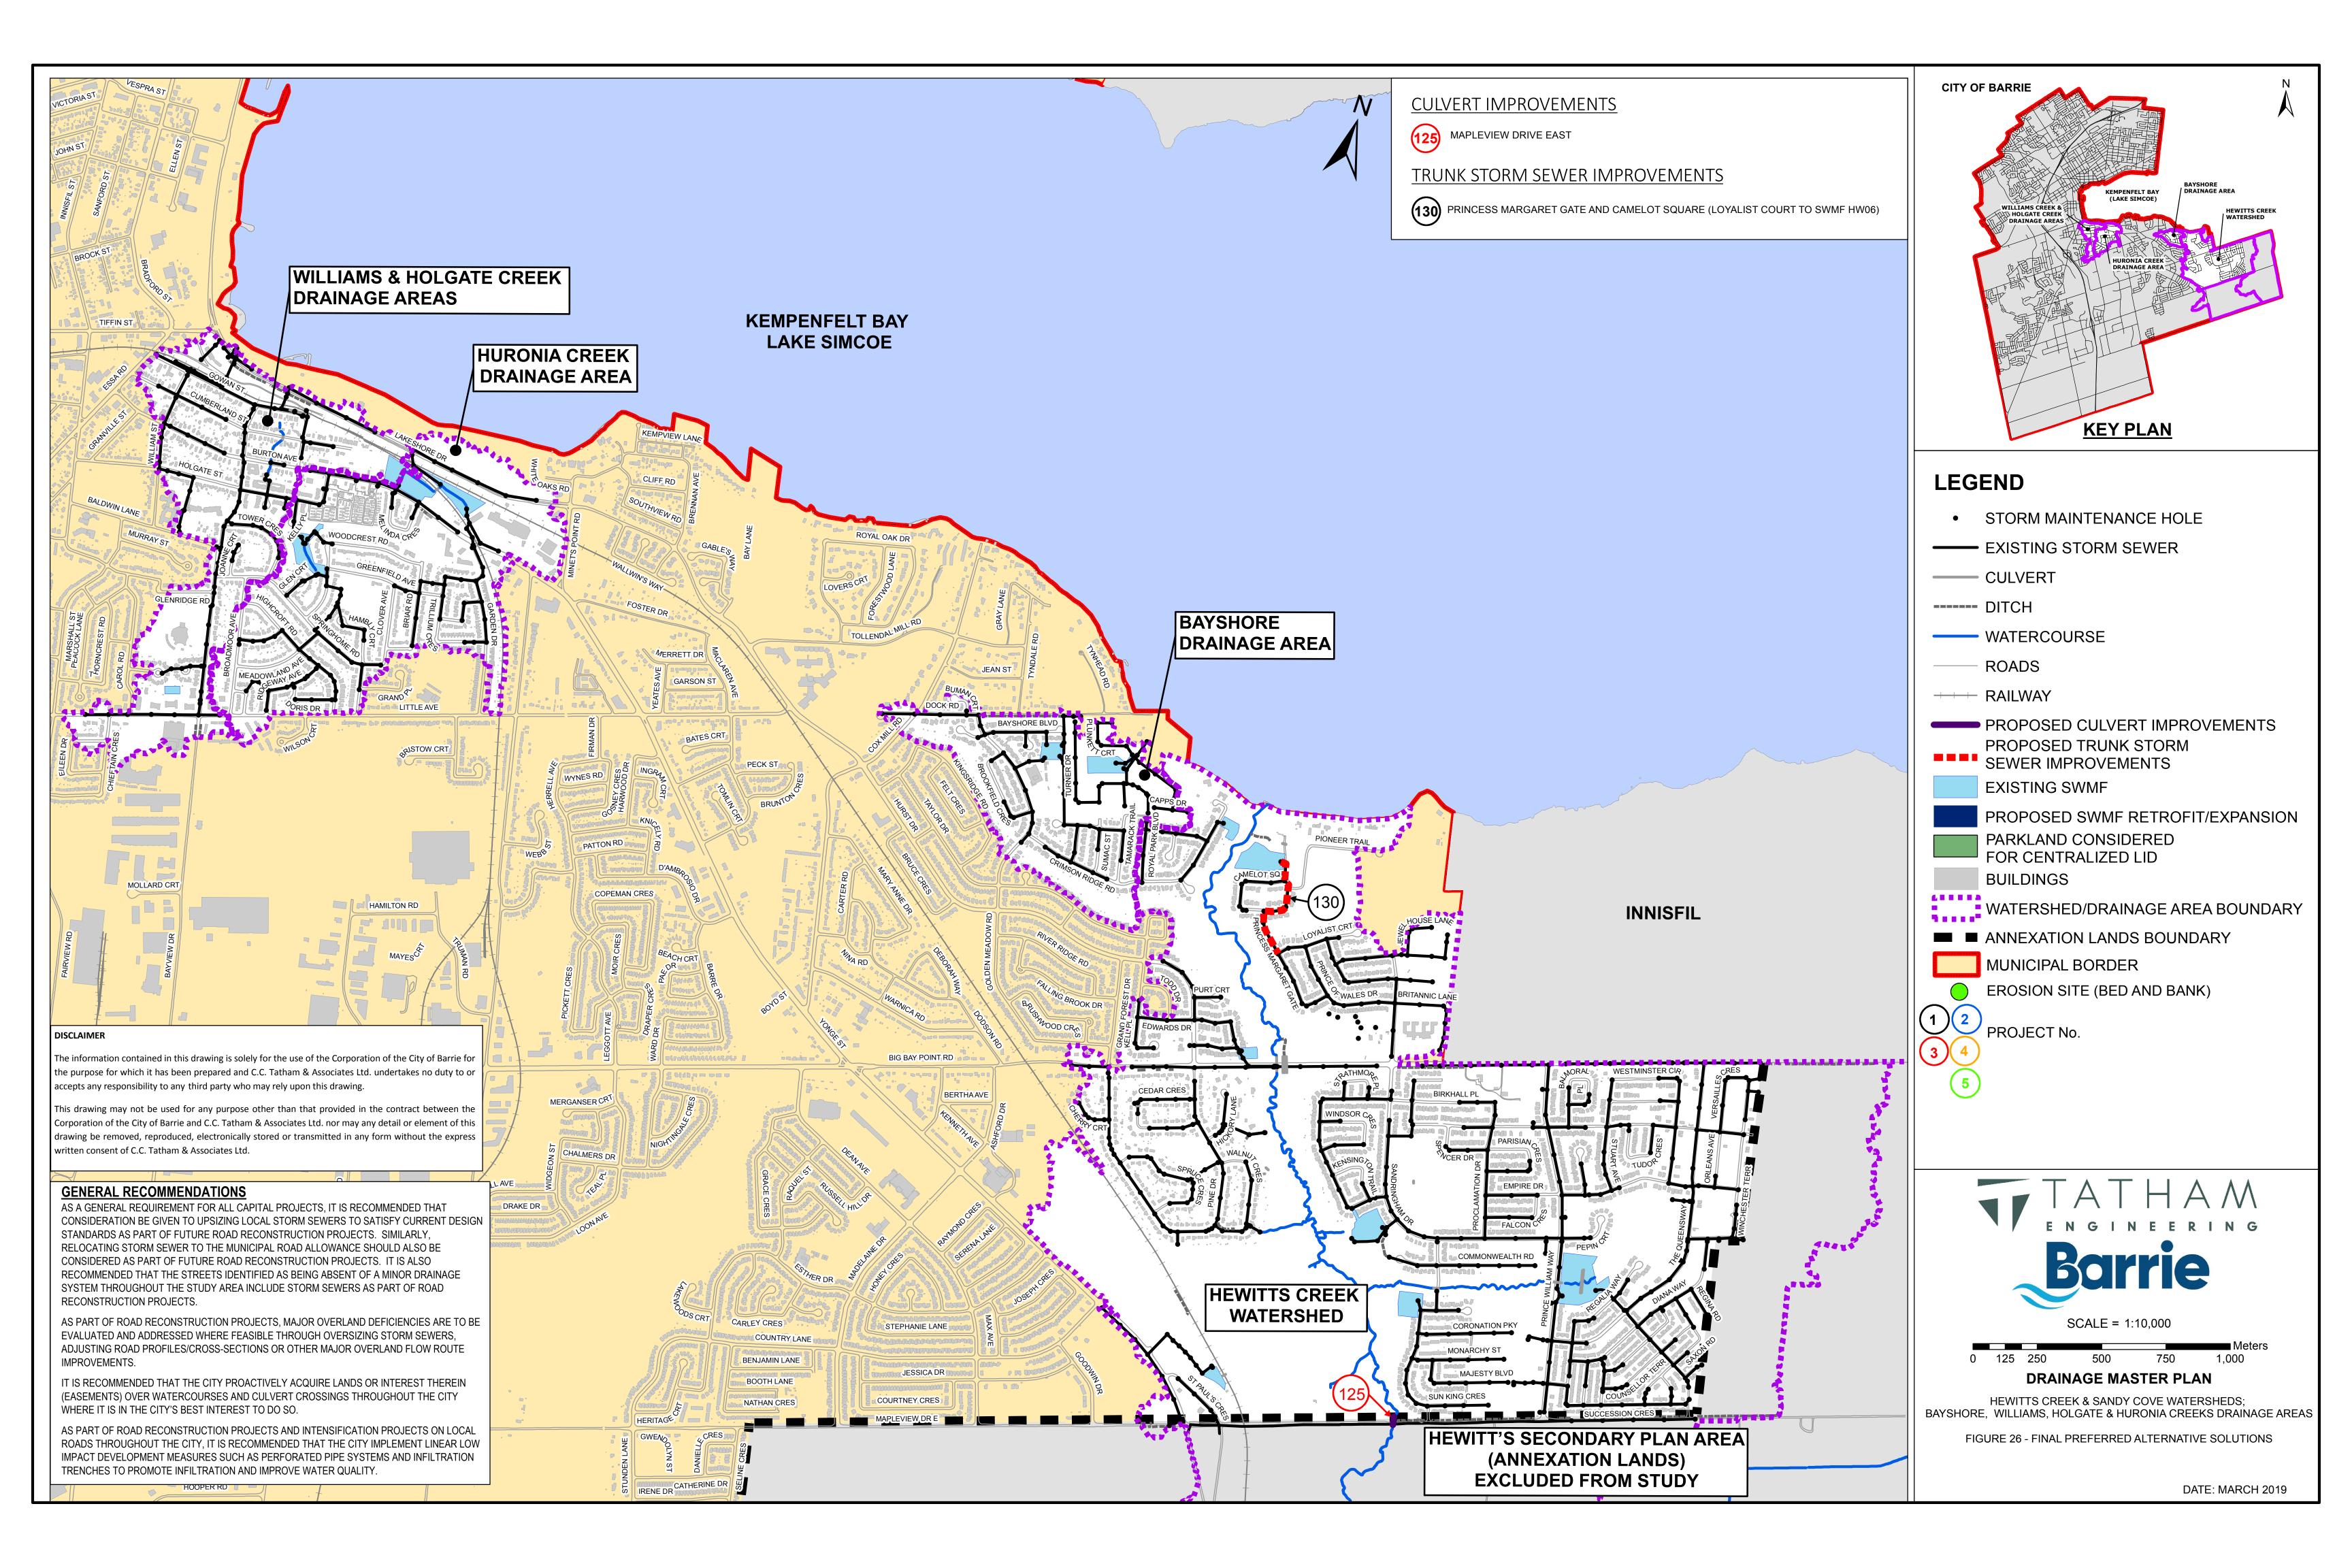
DATE: JUNE/17

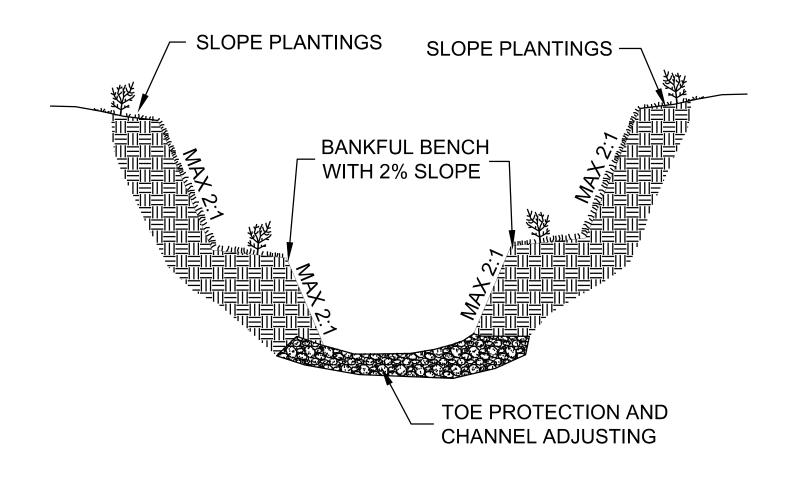












CONFINED NATURAL CHANNEL

N.T.S.



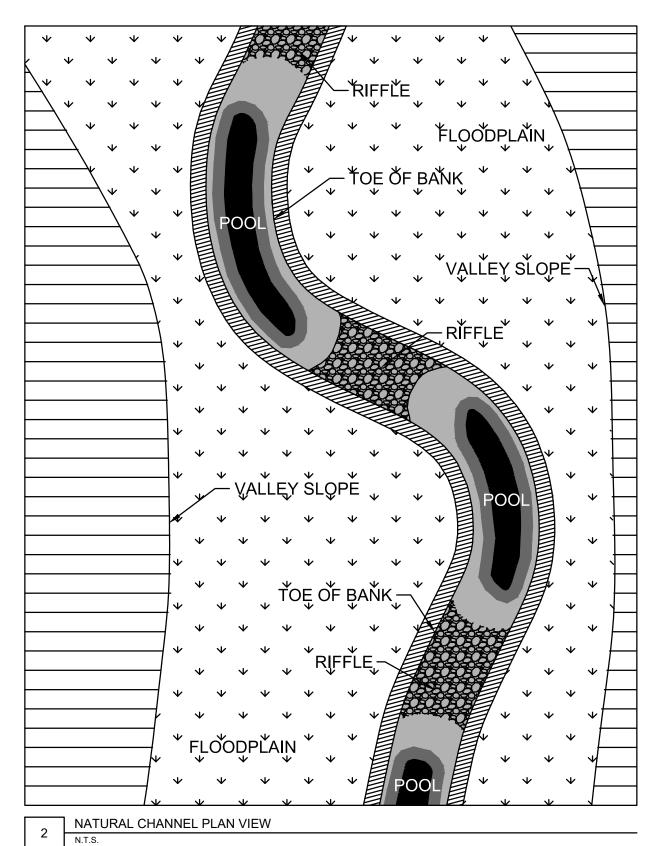
BARRIE MASTER DRAINAGE PLAN

TYPICAL WATERCOURSE IMPROVEMENT DETAILS

DWG. No.

SCALE: NTS


DATE: MAR/19





BARRIE MASTER DRAINAGE PLAN

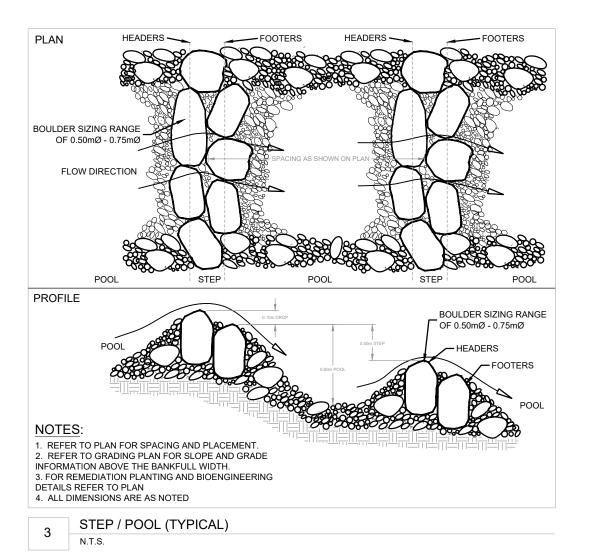TYPICAL WATERCOURSE IMPROVEMENT DETAILS






BARRIE MASTER DRAINAGE PLAN

TYPICAL WATERCOURSE IMPROVEMENT DETAILS


DWG. No.

SCALE: NTS

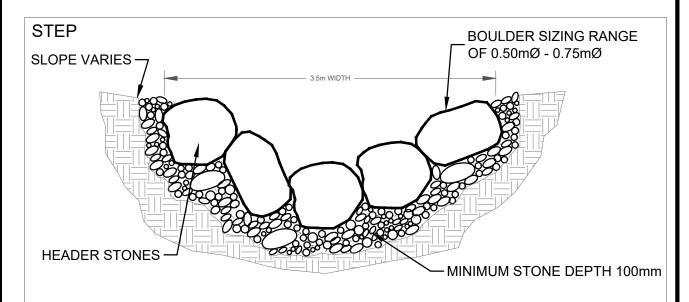DATE: MAR/19



POOL

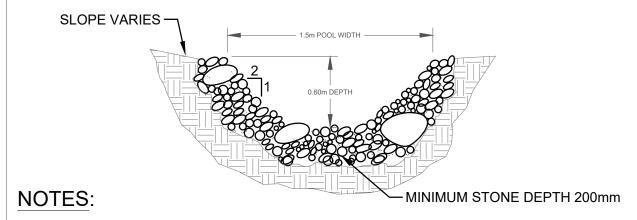

- 1. REFER TO PLAN FOR SPACING AND PLACEMENT.
- 2. REFER TO GRADING PLAN FOR SLOPE AND GRADE INFORMATION ABOVE THE BANKFULL WIDTH.
- 3. FOR REMEDIATION PLANTING AND BIOENGINEERING DETAILS REFER TO PLAN
- 4. ALL DIMENSIONS ARE AS NOTED

4

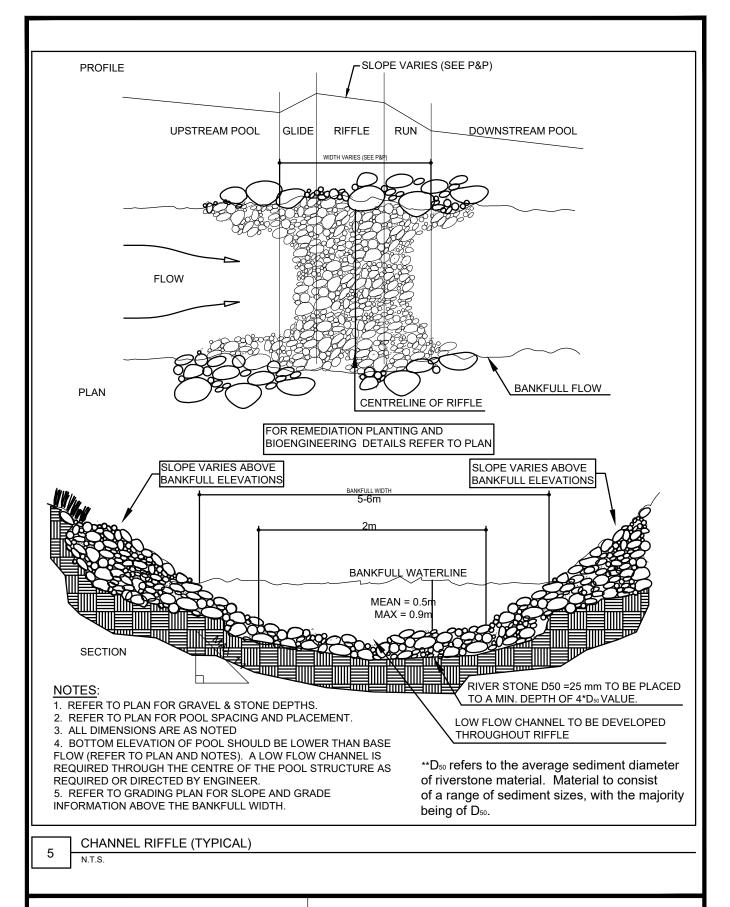
STEP / POOL CROSS SECTION (TYPICAL)

N.T.S.



BARRIE MASTER DRAINAGE PLAN


TYPICAL WATERCOURSE IMPROVEMENT DETAILS





BARRIE MASTER DRAINAGE PLAN

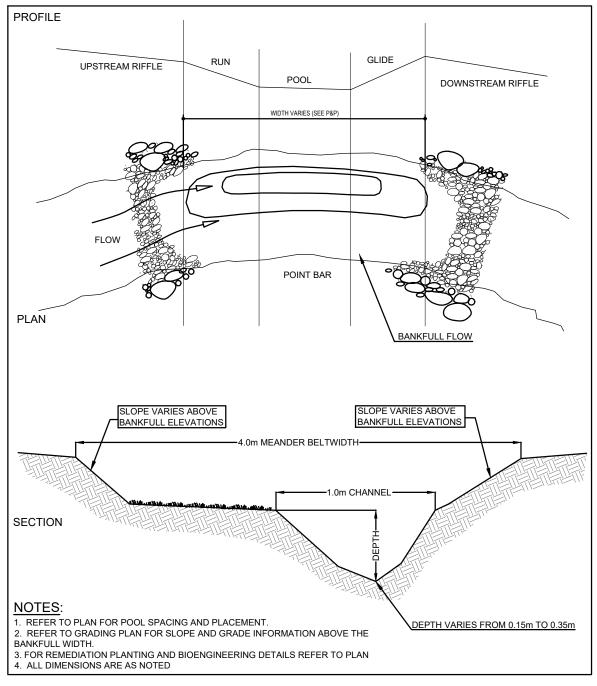TYPICAL WATERCOURSE IMPROVEMENT DETAILS



CHANNEL POOL (TYPICAL)

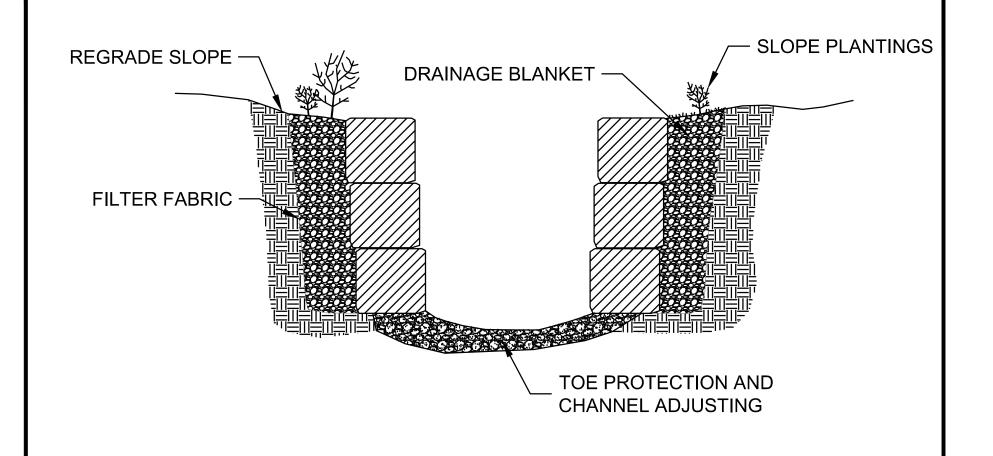
NT

6



BARRIE MASTER DRAINAGE PLAN

TYPICAL WATERCOURSE IMPROVEMENT DETAILS



ARMOURSTONE CHANNEL

N.T.S.



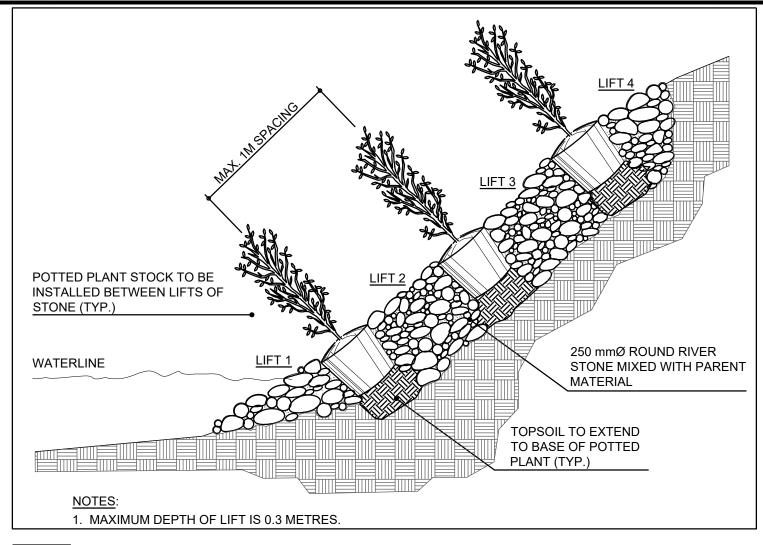
BARRIE MASTER DRAINAGE PLAN

TYPICAL WATERCOURSE IMPROVEMENT DETAILS

DWG. No.

SCALE: NTS

DATE: MAR/19



8

VEGETATED RIVERSTONE (TYPICAL)

N.T.S.



BARRIE MASTER DRAINAGE PLAN

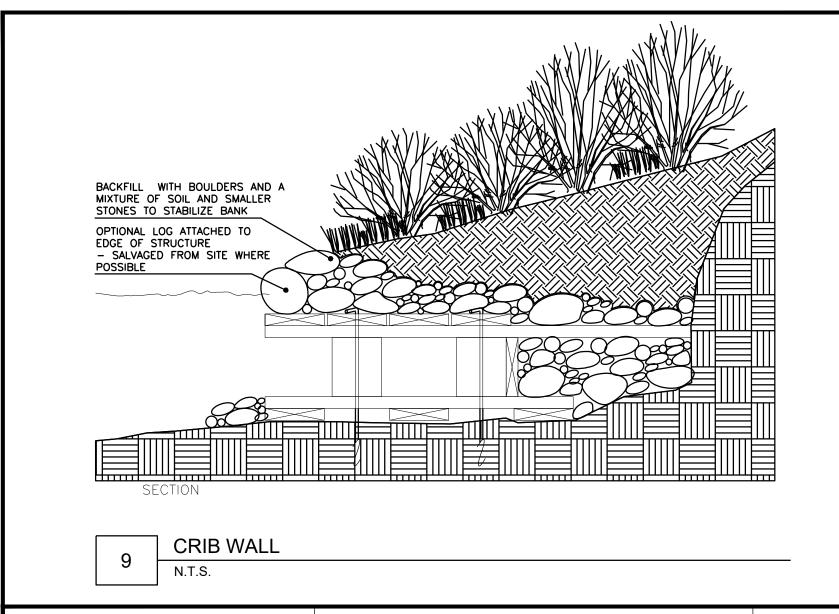
TYPICAL WATERCOURSE IMPROVEMENT DETAILS

DWG. No.

8

SCALE: NTS

DATE: MAR/19





BARRIE MASTER DRAINAGE PLAN

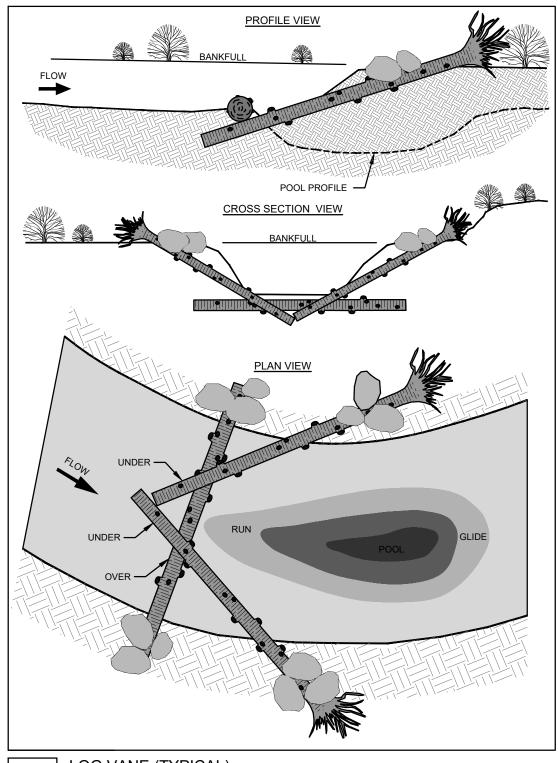
TYPICAL WATERCOURSE IMPROVEMENT DETAILS

SCALE: NTS

DATE: MAR/19

JOB NO. 117076

DWG. No.



LOG VANE (TYPICAL)

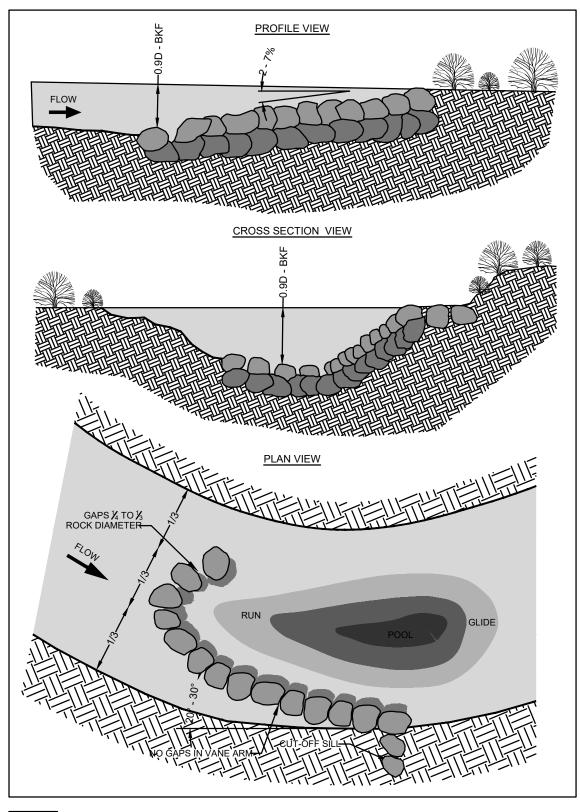
N.T.S.

10



BARRIE MASTER DRAINAGE PLAN

TYPICAL WATERCOURSE IMPROVEMENT DETAILS



11

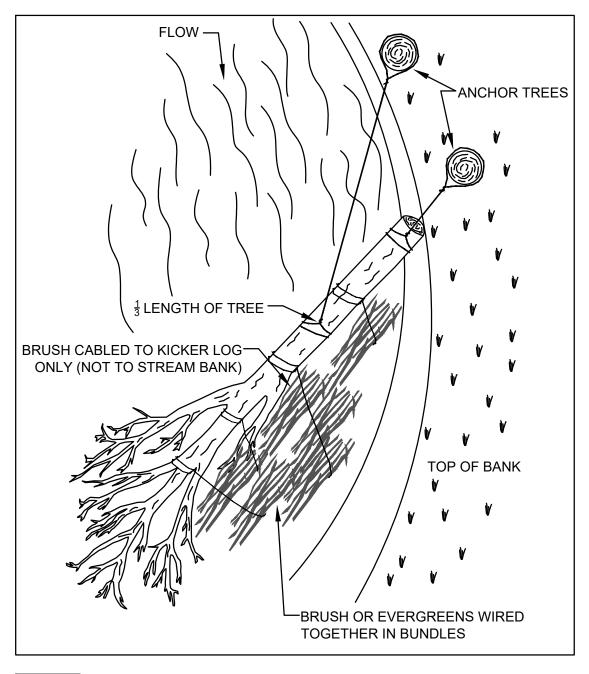
J-HOOK (TYPICAL)

N.T.S



BARRIE MASTER DRAINAGE PLAN

TYPICAL WATERCOURSE IMPROVEMENT DETAILS



12

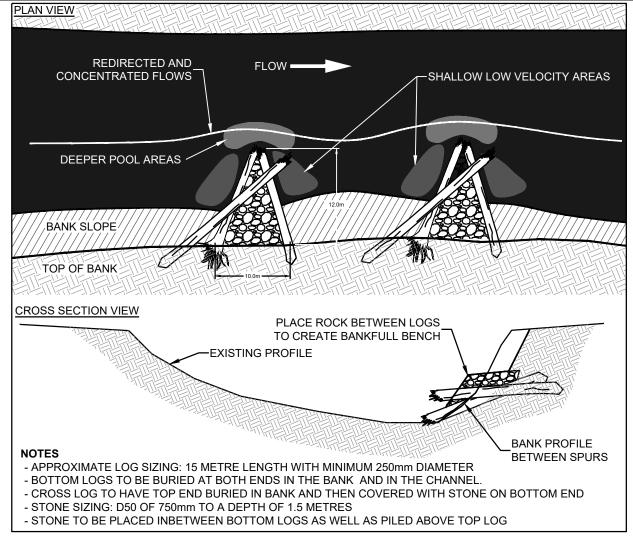
TREE SWEEPER

N.T.S.



BARRIE MASTER DRAINAGE PLAN

TYPICAL WATERCOURSE IMPROVEMENT DETAILS



LOG AND STONE SPUR

N.T.S.

13

BARRIE MASTER DRAINAGE PLAN

TYPICAL WATERCOURSE IMPROVEMENT DETAILS

DWG. No.

13

SCALE: NTS

DATE: MAR/19